## NEW GROUP HOME 7 REX STREET GOULBURN LOT 83 DP 10309

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NP-01	A	NOTIFICATION PLAN



DRAWING AMENDMENTS REVISION DESCRIPTION		DATE	REX ST GROUP HOME	+L TIM LEE ARCHITECTS	DRAWING TITLE	TITLE	DRAWING COMMENCED	DRAWING VERIFIED BY
REVISION A	DESCRIPTION DEVELOPMENT APPLICATION	23/05/2025	DOUBLE SKULL PTY LTD	residential commercial industria P: 02 4822 5934 ABN: 71425067537	LOT AND DEPOSITED PLAN NO.	ED PLAN NO.  LOT 83 DP 10309	DRAWING SCALE	DRAWN BY
			Figured dimensions take precedence. Do not scale drawings.  Builder to check all levels datum and dimensions on the job, conflicting information to be resolved by the project manager prior to commencing work. All materials and workmanship to be in restrict accordance with current Australian standards, BCA, Local regulation	ROSS PLACE GOULBURN NSW 2580 NOMINATED ARCHITECT:		EOT 63 DI 10309	A3 SHEET	JOB NUMBER 1024-1723
			and manufacturers current printed instructions. Unless noted otherwise use only best quality materials, fittings and fixtures.  COPYRIGHT TIM LEE ARCHITECTS  Drawings subject to copyright and may not be reproduced in any form without the written permission of the architect.	TIM LEE NSW REG: 7304 ACT REG: 1030	STREET ADDRESS	7 REX STREET GOULBURN	drawing identification number A-01	AMENDMENT ISSUE

#### NCC & AUSTRALIAN STANDARDS COMPLIANCE NOTES

CONTRACTOR TO SHOW FULL COMPLIANCE WITH ALL <u>CURRENT</u> REQUIRED CODES, STANDARDS, LOCAL LEGISTLATION, BY-LAWS & PARTS OF THE NCC, INCLUDING BUT NOT LIMITED TO THE FOLLOWING:

NCC VOL 2 - PART H1 STRUCTURE NCC VOL 2 - PART H2 NCC VOL 2 - PART H3 DAMP & WATERPROOFING FIRE SAFETY NCC VOL 2 - PART H4 **HEALTH & AMENITY** SAFE MOVEMENT & ACCESS NCC VOL 2 - PART H5 **ENERGY EFFICIENCY** NCC VOL 2 - PART H6 **ANCILLARY PROVISIONS & ADDITIONAL** NCC VOL 2 - PART H7 CONSTRUCTION REQUIREMENTS NCC VOL 2 - PART H8 LIVABLE HOUSING DESIGN NCC VOL 2 - SPEC 42 HOUSE ENERGY RATING SOFTWARE NCC VOL 2 - SPEC 44 CALCULATION OF HEATING LOAD LIMIT COOLING LOAD LIMIT & THERMAL ENERGY LOAD LIMIT NCC VOL 2 - SCHEDULE 3 COMMONWEALTH OF AUSTRALIA NCC VOL 2 - SCHEDULE 4 **AUSTRALIAN CAPITAL TERRITORY** NCC VOL 2 - SCHEDULE 5 **NEW SOUTH WALES** 

## LIGHT & VENTILATION IS REQUIRED TO ALL BUILDINGS TO MEET NCC VOL 2. PART H4.

VOL 2. PART H4.	
BCA (NCC) VOL. 2	PART 3.12.3 - BUILDING SEALING
BCA (NCC) VOL. 2	PART 3.12.5 - SERVICES
AS/NZS 1170.2 : 2011	STRUCTURAL DESIGN ACTIONS - WIND ACTIONS
AS 1288 : 2006	GLASS IN BUILDINGS BCA (NCC) CLAUSE B1.4 $\&$ PART 3.1.4
AS 1562 : 2018	DESIGN & INSTALLATION OF SHEET ROOFING & WALL CLADDING
AS/NZS 1596 : 2014	THE STORAGE AND HANDLING OF LP GAS
AS 1684.2 : 2010	RESIDENTIAL TIMBER-FRAMED CONSTRUCTION - NON-CYCLONIC AREA - N1/N2 SUPPLEMENT 1: TIMBER FRAMING SPAN TABLES - WIND CLASSIFICATION N1/N2 - SEASONED SOFTWOOD - STRESS GRADE F5 (SUPPLEMENT TO AS 1684.2: 2010).
AS 1684.2 : 2012	RESIDENTIAL TIMBER-FRAMED CONSTRUCTION
AS 1668.2 : 2012	THE USE OF VENTILATION & AIR-CONDITIONING IN BUILDINGS
AS 2047 : 2014	GLAZING ASSEMBLIES & BCA (NCC) B1.4 & F1.13
AS 2436 : 2010	GUIDE TO NOISE & VIBRATION CONTROL ON CONSTRUCTION, DEMOLITION & MAINTENANCE SITES
AS/NZS 2589 : 2017	GYPSUM LININGS - APPLICATIONS & FINISHING
AS 2870 : 2011	RESIDENTIAL SLABS & FOOTINGS
AS/NZS 2904 : 1995	DAMP-PROOF COURSES & FLASHINGS
AS/NZS 3000 : 2018	ELECTRICAL INSTALLATIONS/WIRING
AS/NZS 3008 : 2017	ELECTRICAL INSTALLATIONS
AS/NZS 3012 : 2010	ELECTRICAL INSTALLATIONS - CONSTRUCTION & DEMOLITION SITES
AS/NZS 3500.3 : 2015	PLUMBING & DRAINAGE - STORMWATER DRAINAGE
AS 3660.1 : 2014	TERMITE MANAGEMENT PART 1 : NEW BUILDING WORK & BCA (NCC) VOL. 2 PART 3.1.4
AS 3666.1 : 2011	AIR HANDLING & WATER SYSTEMS OF BUILDING - MICROBIAL CONTROL
AS 3700 : 2018	MASONRY STRUCTURES

PAVEMENTS - RESIDENTIAL

AS 3727.1:2016

#### BCA (NCC) & AUSTRALIAN STANDARDS COMPLIANCE NOTES

AS 3740 : 2021	WATERPROOFING OF DOMESTIC WET AREAS & BCA (NCC) VOL. 2 PART 3.8.1
AS 3786 : 2014	SMOKE ALARMS USING SCATTERED LIGHT, TRANSMITTED LIGHT OR IONIZATION & BCA (NCC) VOL. 2 PART 3.7.5
AS 4055 : 2012	WIND LOADS FOR HOUSING
AS 4349 : 2007	INSPECTION OF BUILDINGS
AS/NZS 4654 : 2012	WATERPROOFING MEMBRANES FOR EXTERNAL ABOVE-GROUND USE BCA (NCC) VOL. 2 PART 3.8.1
AS 4773 : 2015	MASONRY IN SMALL BUILDINGS - DESIGN
AS 5104 : 2017	GENERAL PRINCIPLES ON RELIABILITY FOR STRUCTURES
HB 28 : 1997	THE DESIGN OF RESIDENTIAL SLABS & FOOTINGS
HB 46 : 2010	FIRE SAFETY IN THE HOME
HB 111 : 1998	THE DOMESTIC KITCHEN HANDBOOK

## SCHEDULE OF FIRE SAFETY MEASURES EMERGENCY LIGHTING NCC

EMERGENCY LIGHTING
PORTABLE FIRE EXTINGUISHERS
FIRE BLANKETS
EXIT DOORS
NCC PART E1D14, AS 2444
NCC PART E1D14, AS 2444
NCC PART E1D14, AS 2444
NCC PART D3, INC. D3D24, D3D25, D3D26, D3D28
NOTE: EMERGENCY DOORS TO REMAIN CLEAR AT ALL TIMES.

CONTRACTOR TO "DIAL BEFORE YOU DIG" BEFORE ANY WORKS ARE CARRIED OUT.

#### ASBESTOS REMOVAL NOTES (if found):

IF & WHEN ASBESTOS IS FOUND, WORK IS TO STOP IMMEDIATELY & A LICENSED ASBESTOS REMOVALIST IS TO BE ENGAGED TO REMOVE THE ASBESTOS

THE ASSESSMENT, REMOVAL & DISPOSAL OF ASBESTOS TO MEET ALL AUSTRALIAN STANDARDS, NCC (BCA) REQUIREMENTS & "HOW TO SAFELY REMOVE ASBESTOS - CODE OF PRACTICE" APRIL 2016 BY SAFE WORK AUSTRALIA, APPROVED CODE OF PRACTIVE UNDER SECTION 274 OF THE "WORK HEALTH & SAFETY ACT" (THE WHS ACT) & THE "WORK HEALTH & SAFETY REGULATIONS" (THE WHS REGULATIONS).

THE REMOVAL OF ASBESTOS IS TO BE ACCESSED & CARRIED OUT BY A LICENSED ASBESTOS REMOVALIST WHO IS APPROPRIATELY LICENSED TO CARRY OUT THE SCOPE OF WORKS.

THE LICENSED ASBESTOS REMOVALIST MUST PREPARE AN ASBESTOS REMOVAL CONTROL PLAN FOR ANY LICENSED ASBESTOS REMOVAL WORK THEY ARE COMMISSIONED TO CARRY OUT. THE ASBESTOS REMOVAL CONTROL PLAN TO BE PREPARED PRIOR TO COMMENCEMENT OF WORKS

DURING THE REMOVAL & DISPOSAL OF THE ASBESTOS, THE LICENSED ASBESTOS REMOVALIST IS TO ENSURE DECONTAMINATION FACILITIES, WASTE CONTAINMENT & DISPOSAL METHODS MEET THE ABOVEMENTIONED RULES & REGULATIONS.

IF ASBESTOS CONTAMINATED SOIL IS DISCOVERED DURING WORKS & EXCAVATION ONSITE, ALL WORK IS TO CEASE IMMEDIATELY. THE LICENSED ASBESTOS REMOVALIST IS TO BE CONTACTED IMMEDIATELY & AWAIT THEIR INSTRUCTIONS.

#### NOTES:

ALL LEVELS SHOWN ARE BASED ON SUPPLIED 3rd PARTY SURVEY INFORMATION. TIM LEE ARCHITECTS ACCEPTS NO RESPONSIBILITY OR INDEMNITY FOR THE ACCURACY OF SUPPLIED SITE INFORMATION. IT IS THE CONTRACTOR'S RESPONSIBILITY TO CONFIRM ALL LEVELS ON SITE PRIOR TO COMMENCING ANY EXCAVATION OR SITE WORKS. TIM LEE ARCHITECTS TO BE NOTIFIED OF ANY ANOMALIES PRIOR TO THE CONTRACTOR STARTING ANY WORKS. ALL BUILDING WORKS, SIGNAGE, FITTINGS & FIXTURES TO BE INSTALLED IN STRICT ACCORDANCE TO MEET AS 1428.1 & BE INSTALLED TO MANUFACTURER'S CURRENT PRINTED INSTRUCTIONS.

#### NOTES:

CA REGISTERED SURVEYOR TO ESTABLISH BOUNDARY & SET OUT BUILDING IN STRICT ACCORDANCE WITH THIS DOCUMENTATION SET. ALL DIMENSIONS SUBJECT TO SITE SURVEY.

SUPPLY & INSTALL ALL NECESSARY FITTINGS & FIXTURES IN STRICT ACCORDANCE WITH MANUFACTURER'S CURRENT PRINTED INSTRUCTIONS.

ALL FLOOR LEVELS & GROUND LEVELS ARE ASSUMED & ARE TO BE CONFIRMED ONSITE, PRIOR TO COMMENCING ANY WORKS.

IT IS THE RESPONSIBILITY OF THE CONTRACTOR AND SUB-CONTRACTORS TO MAKE THEMSELVES FULLY AWARE OF CONDITIONS WHICH WILL AFFECT THE EXECUTION OF THE WORKS.

THE CONTRACTOR IS TO ENSURE COMPLETE COMPLIANCE WITH ALL RELEVANT NCC CODES, AUSTRALIAN STANDARDS AND LOCAL REGULATIONS AND BY-LAWS AS REQUIRED.

ALL MATERIALS & WORKMANSHIP ARE TO BE IN STRICT ACCORDANCE WITH THE MANUFACTURER'S CURRENT PRINTED INSTRUCTIONS.

ALL MATERIALS & WORKMANSHIP ARE TO BE OF BEST QUALITY UNDERTAKEN BY FULLY QUALIFIED TRADESMEN. ALL MATERIALS TO BE SUPPLIED NEW. ALL DAMAGED MATERIALS TO BE REJECTED AND REPLACED WITH NEW.

IF ALTERNATIVE MATERIAL OR PRODUCT IS PROPOSED TO THAT SPECIFIED, THE BUILDER MUST PROVIDE EVIDENCE SHOWING COMPLIANCE WITH THE BCA AND ALL RELEVANT STANDARDS RELATING TO THE APPLICATION OF THE PROPOSED MATERIAL. FURTHER THE ARCHITECT ACCEPTS NO LIABILITY OR INDEMNITY FOR THE SUBSTITUTION OF A MATERIAL CONTRARY TO THAT SPECIFIED BY THE ARCHITECT WITHOUT THE PROVISION OF WRITTEN DOCUMENTATION SHOWING COMPLIANCE WITH THE BCA AND AUSTRALIAN STANDARDS AND THE EXPRESS WRITTEN APPROVAL OF THE ARCHITECT.

THE CONTRACTOR IS TO NOTIFY THE PROJECT MANAGER OF ANY ERRORS OR OMISSIONS IN THE DOCUMENTATION PRIOR TO COMMENCING WORK. THE PROJECT MANAGER TO CONTACT THE APPROPRIATE CONSULTANT FOR ADVICE PRIOR TO COMMENCING THE WORKS.

COMMENCEMENT OF THE WORKS BY THE CONTRACTOR CONSTITUTES A FULL UNDERSTANDING OF THE PROJECT & ACCEPTANCE OF ALL SITE CONDITIONS & THE SUPPLIED DOCUMENTATION.

TIM LEE ARCHITECTS ACCEPTS NO RESPONSIBILITY OR INDEMNITY FOR CONDITIONS, LATENT OR OTHERWISE, ARISING WITHOUT NOTIFICATION PRIOR TO COMMENCING THE WORKS.

ALL WORK TO BE CARRIED OUT BY COMPETENT, SKILLED & QUALIFIED TRADESPEOPLE HOLDING CURRENT CERTIFICATION WITH THE REQUIRED AUTHORITY.

PROVIDE ALL MATERIALS, LABOUR & EQUIPMENT NECESSARY TO COMPLETE THE WORK AS PER THE DRAWING SET & ASSOCIATED DOCUMENTATION.

GRADE FINISHED GROUND LINE TO GIVE FALLS AWAY FROM BUILDINGS.

PROVIDE TERMITE CONTROL TO ALL AREAS AS REQUIRED BY PART B OF THE BCA, AS 3660.1 & 3660.2.

INSTALL HARD WIRED SMOKE ALARMS TO AS 3786 ADJACENT TO SLEEPING AREAS AS DIRECTED ONSITE.

ALL WALLS TO BE WRAPPED IN ENVIROSEAL RESIDENTIAL WALL WRAP. ALL JOINTS TO BE LAPPED MIN. 300mm AND TAPED.

RANGE HOODS EXHAUST SYSTEMS TO HAVE A MINIMUM FLOW RATE OF 40L/s.

EXHAUSTS FROM BATHROOMS & LAUNDRY MUST BE DISCHARGED DIRECTLY OR VIA A SHAFT OR DUCT TO OUTSIDE AIR.

MECHANICAL VENTILATION & LIGHTING TO MEET PART H4 OF THE NCC. INSTALL TO MANUFACTURER'S CURRENT PRINTED INSTRUCTIONS.

#### NOTES:

ONCE WINDOWS ARE INSTALLED, CONTRACTOR TO SEAL WINDOW PERIMETERS WITH SPRAY FOAM TO GIVE FULLY AIR-TIGHT SEAL AGAINST FRAME. INSTALL TO MANUFACTURER'S CURRENT PRINTED INSTRUCTIONS.

SITE PREPARATION SHALL BE CARRIED OUT IN ACCORDANCE WITH ENGINEER'S DETAILS & CURRENT EDITION OF AS2870 - RESIDENTIAL SLABS & FOOTING CODE.

A JAS-ANZ ACCREDITED 3RD PARTY PROCESSOR CERTIFICATE (ACRS

OR EQUIVALENT) MUST BE SUPPLIED WITH ALL STEEL REINFORCEMENT AT PROCUREMENT, BEFORE ANY CONCRETE IS PLACED TO GUARANTEE CONFORMANCE OF THE REINFORCEMENT TO AS/NZS 4671.

LIFT OFF HINGES TO ALL WC COMPARTMENT DOORS WHERE OPENING INWARDS TO SATISFY THE REQUIREMENTS OF NCC PART 10.4.2 OR PROVIDE ALTERNATIVE CONFIGURATION TO SATISFY THE LOCAL AUTHORITIES.

CLADDING TO BE INSTALLED IN ACCORDANCE WITH MANUFACTURER'S CURRENT PRINTED INSTRUCTIONS. INSTALL OVER ENVIROSEAL RW. LAP & TAPE ALL JOINTS & FRAME PENETRATIONS TO ENSURE AN AIRTIGHT BUILDING SEAL.

ALL FIRST FLOOR WINDOWS TO HAVE A CHILD RESTRICTIVE OPENING

DEVICE TO PREVENT THEM OPENING MORE THAN 120mm TO MEET D2.24 OF THE BCA. INSTALL TO MANUFACTURER'S CURRENT PRINTED INSTRUCTIONS.

ALL PAINT FINISHES (EXTERNAL AND INTERNAL) TO BE LEVEL 4 PAINT FINISH (MIN. 4 COATS), SEAL COAT, UNDERCOAT, 2 x TOP COATS

ALL EXTERNALL LOCATED MANUFACTURED TIMBER PRODUCTS TO BE PROTECTED IN ACCORDANCE WITH MANUFACTURER'S CURRENT PRINTED INSTRUCTIONS.

#### WET AREAS

WET AREAS SHOWN HATCHED, LAY NON-SLIP CERAMIC TILES TO EQUAL R11/P4 SLIP RATING ON MORTAR BED GRADED TO GIVE FALLS TO FW'S AS SHOWN AND TO MEET NCC F2D2. AREAS TO BE TREATED IN ACCORDANCE WITH AUSTRALIAN STANDARDS AS 3740 WATERPROOFING OF WET AREAS WITHIN RESIDENTIAL BUILDINGS.

THE WATERPROOFING SYSTEM TO BE APPROPRIATE FOR THE BASE CONSTRUCTION. DO NOT WATERPROOF OVER PARTICLE BOARD

TIMBER FLOORING.

PROVIDE EVIDENCE OF MANUFACTURER'S PRODUCT INSTALLATION DATA SHEETS & REQUIREMENTS.

INSTALL ALL PRODUCTS TO MANUFACTURER'S CURRENT PRINTED INSTRUCTIONS.

#### TILING

TILING TO BE COMPLETED WITH NO RAISED EDGES OR TIGHT JOINTS.

APPROPRIATE TRIMS & FINISH BEADS TO BE INSTALLED.


SUB-STANDARD TILING WILL BE REJECTED. REJECTED WORK TO BE REMOVED. BASE WORK IS TO BE REPREPARED & NEW MATCHING MATERIALS SUPPLIED & LAID AT CONTRACTOR'S EXPENSE.


NOTE: SITE INFORMATION HAS BEEN ASSUMED, FINAL SET OUT, SITE LEVELS, CONTOURS, FLOOR LEVELS, ETC, TO BE CONFIRMED ONSITE BY SURVEYOR PRIOR TO COMMENCING

DEVELOPMENT APPLICATION

NOT FOR CONSTRUCTION

#### DRAWING AMENDMENTS +L TIM LEE REX ST GROUP HOME **GENERAL NOTES** 12/24 TL **▲ ARCHITECTS** REVISION DESCRIPTION DATE CHENT DEVELOPMENT APPLICATION DOUBLE SKULL PTY LTD P: 02 4822 5934 AΗ 1:100 LOT 83 DP 10309 ROSS PLACE Figured dimensions take precedence. Do not scale drawing: **GOULBURN NSW** Builder to check all levels datum and dimensions on the job, conflicting information to be resolved by the project manager prior to A3 SHEET 2580 1024-1723 commencing work. All materials and workmanship to be in restrict accordance with current Australian standards, BCA, Local regulation and manufacturers current printed instructions. Unless noted otherwise use only best quality materials, fittings and fixtures. NOMINATED ARCHITECT DRAWING IDENTIFICATION NUMBER AMENDMENT ISSUE COPYRIGHT TIM LEE ARCHITECTS 7 REX STREET GOULBURN NSW REG: 7304 Drawings subject to copyright and may not be reproduced in any form without the written permission of the architec A-02

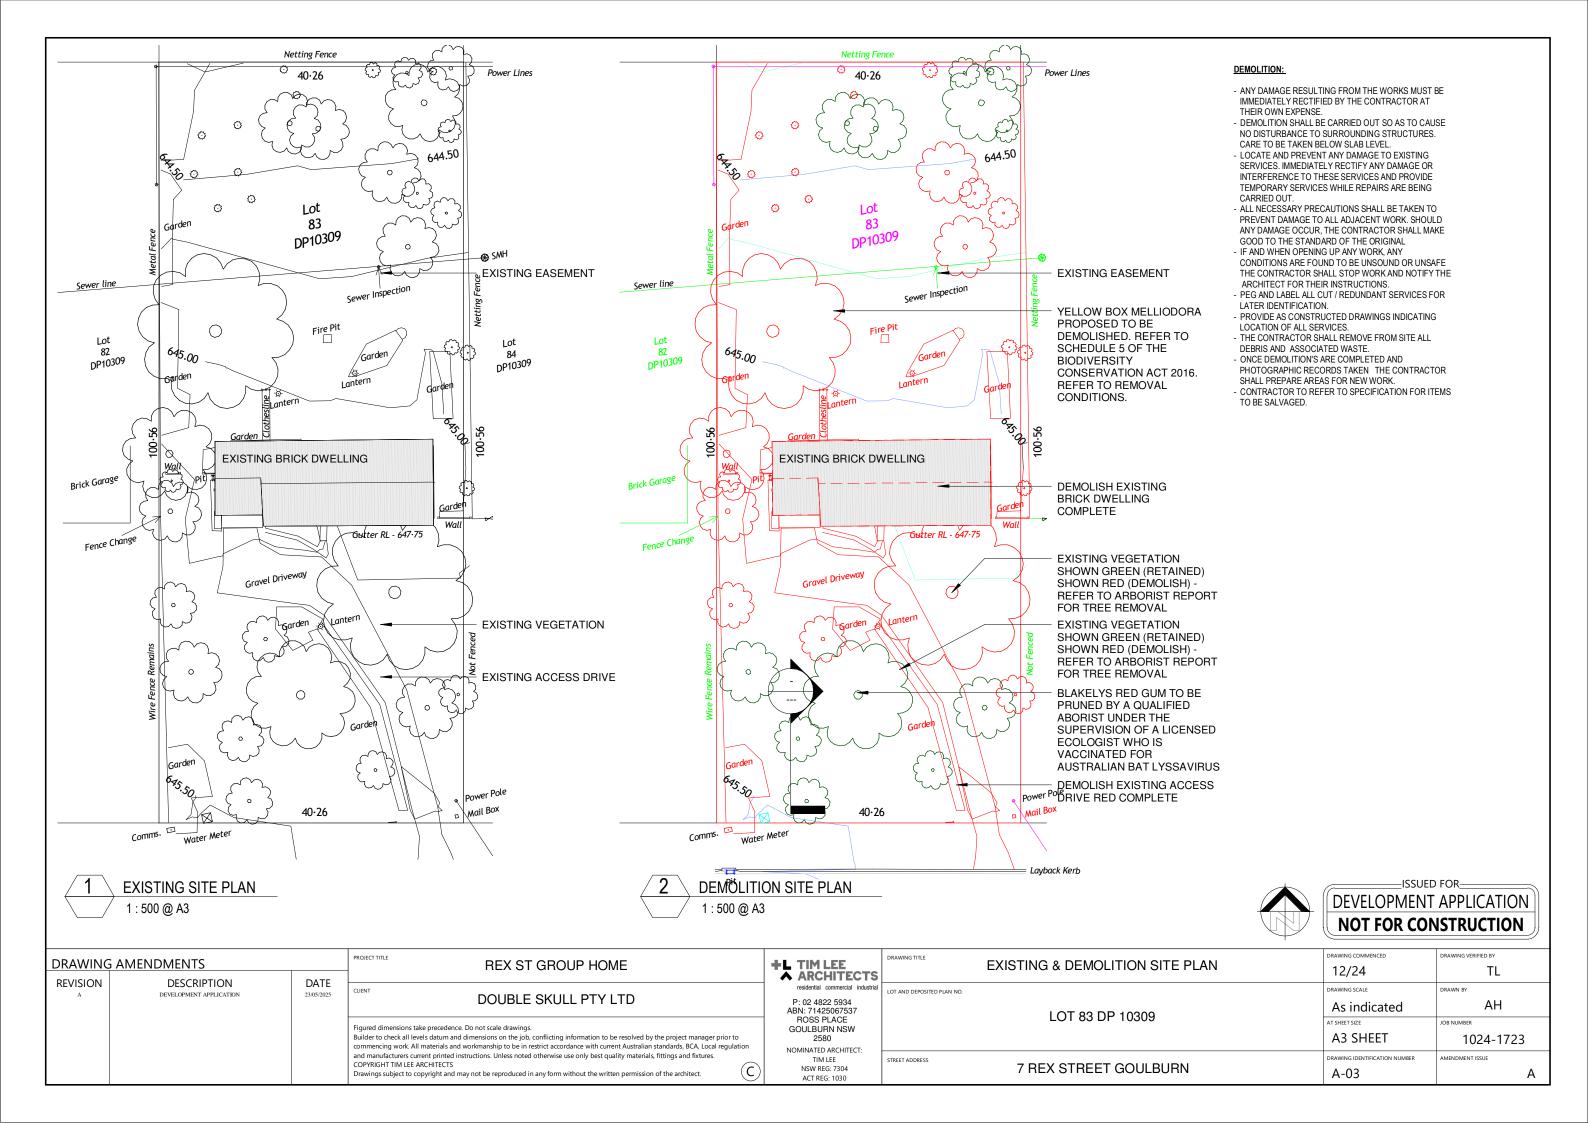

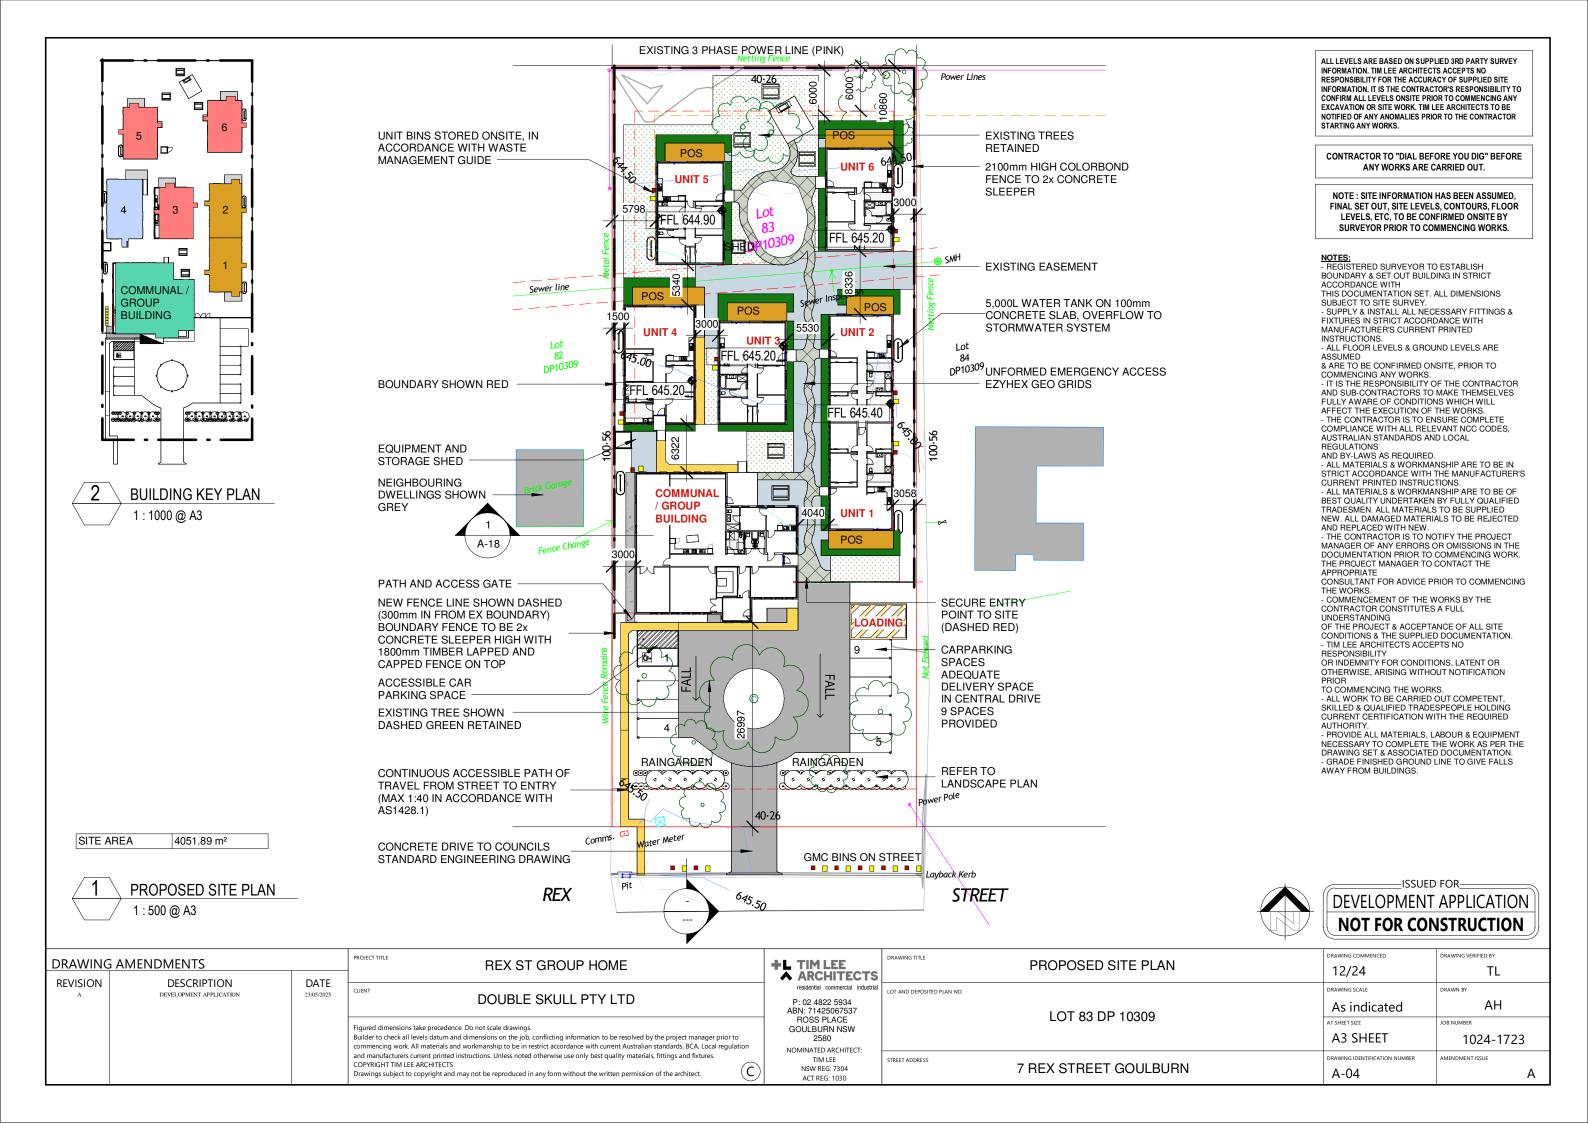

#### **EXISTING 3 PHASE POWER LINE (PINK)** BASIX COMMITMENTS: <u>WATER</u> Power Lines Alternative water supply:3,000L tank collected from 615m2 roof area and servicing laundry, toilets Dwelling fixtures: Showerheads - 4 star UNIT BINS STORED ONSITE, IN **EXISTING TREES** (>4.5 L/min and <7.5L/min); Toilets 4 star; ACCORDANCE WITH WASTE **POS** RETAINED Kitchen/Bathroom Taps 4 Star UNIT 6 644 MANAGEMENT GUIDE THERMAL COMFORT 2100mm HIGH COLORBOND Glazing: FENCE TO 2x CONCRETE **OUTDOOR REC AREA** Maximum U-Value 4.8 SHGC 0.48 - 0.54 SLEEPER AND SEATING UNDER (awning) **TREES** Maximum U-Value 4.8 SHGC 0.56 - 0.62 (sliding, fixed) SHED Insulation: Minimum R5 insulation to be installed to ceiling with R1.3 blanket **EXISTING EASEMENT** Minimum R1.0 insulation under-slab of dwelling 1 and 2 Sewer line POS Minimum R2.5 insulation to be installed POS 5,000L WATER TANK ON 100mm POS to external walls with reflective foil CONCRETE SLAB, OVERFLOW TO Minimum R2 insulation to be installed to STORMWATER SYSTEM UNIT 2 internal walls facing unconditioned **UNIT 4** UNIT 3 zones (wc, ldry, bath) 545.00 Lighting: Any downlights to be LED, IC-F DP10309 compliant so as to allow full coverage of insulation. **BOUNDARY SHOWN RED** Ventilation: All exhaust fans to be sealed. Colour: Medium (SA 0.5) External walls, Roof and Windows **ENERGY** Hot water: 5 star gas instantaneous hot **EQUIPMENT AND** EME water system STORAGE SHED Ventilation: Bathroom, kitchen, laundry ED have individual exhaust fan ducted to **NEIGHBOURING** roof/facade with manual switch on/off **COMMUNAL** DWELLINGS SHOWN GREY -Cooling/heating: 1 Phase/≥3.5 star (new **GROUP** UNIT 1 rating) individual system in Living 5,000L WATER TANK ON 100mm BUILDING CONCRETE SLAB, OVERFLOW TO Lighting: LED, IC-F Compliant throughout STORMWATER SYSTEM POS Cooktop/oven: Electric cooktop & electric oven Fridge: Ventilated fridge space PATH AND ACCESS GATE SECURE ENTRY Clothes drying: Indoor clothes drying line POINT TO SITE **MATERIALS NEW FENCE LINE SHOWN DASHED** (DASHED RED) LOADING (300mm IN FROM EX BOUNDARY) Refer to construction in BASIX report. **BOUNDARY FENCE TO BE 2x** CONCRETE SLEEPER HIGH WITH 1800mm COLORBOND FENCE ON TOP **CARPARKING SPACES ADEQUATE** ACCESSIBLE CAR DELIVERY SPACE PARKING SPACE IN CENTRAL DRIVE 9 SPACES **EXISTING TREE PROVIDED** 4 SHOWN DASHED 5 GREEN AREA OF RETAINED **LANDSCAPING** SHOWN HATCHED **GREEN** CONCRETE DRIVE TO COUNCILS STANDARD ENGINEERING DRAWING 40.26 vater Meter SITE AREA 4051.89 m<sup>2</sup> GMC BINS ON STREET Layback Kerb PROPOSED ROOF LEVEL SITE PLAN Pit REX 645.<u>50</u> STREET 1:500 @ A3

ALL LEVELS ARE BASED ON SUPPLIED 3RD PARTY SURVEY INFORMATION. TIM LEE ARCHITECTS ACCEPTS NO RESPONSIBILITY FOR THE ACCURACY OF SUPPLIED SITE INFORMATION. IT IS THE CONTRACTOR'S RESPONSIBILITY TO CONFIRM ALL LEVELS ONSITE PRIOR TO COMMENCING ANY EXCAVATION OR SITE WORK, TIM LEE ARCHITECTS TO BE NOTIFIED OF ANY ANOMALIES PRIOR TO THE CONTRACTOR STARTING ANY WORKS.

CONTRACTOR TO "DIAL BEFORE YOU DIG" BEFORE ANY WORKS ARE CARRIED OUT.

NOTE: SITE INFORMATION HAS BEEN ASSUMED, FINAL SET OUT, SITE LEVELS, CONTOURS, FLOOR LEVELS, ETC, TO BE CONFIRMED ONSITE BY SURVEYOR PRIOR TO COMMENCING WORKS.

NOTES:
- REGISTERED SURVEYOR TO ESTABLISH
BOUNDARY & SET OUT BUILDING IN STRICT
ACCORDANCE WITH

THIS DOCUMENTATION SET. ALL DIMENSIONS SUBJECT TO SITE SURVEY.
- SUPPLY & INSTALL ALL NECESSARY FITTINGS &

FIXTURES IN STRICT ACCORDANCE WITH MANUFACTURER'S CURRENT PRINTED INSTRUCTIONS

ALL FLOOR LEVELS & GROUND LEVELS ARE ASSUMED

& ARE TO BE CONFIRMED ONSITE, PRIOR TO COMMENCING ANY WORKS.
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- THE CONTRACTOR IS TO NOTIFY THE PROJECT

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- COMMENCEMENT OF THE WORKS BY THE CONTRACTOR CONSTITUTES A FULL UNDERSTANDING OF THE PROJECT & ACCEPTANCE OF ALL SITE

CONDITIONS & THE SUPPLIED DOCUMENTATION.
- TIM LEE ARCHITECTS ACCEPTS NO

OR INDEMNITY FOR CONDITIONS, LATENT OR OTHERWISE, ARISING WITHOUT NOTIFICATION


PHIOR
TO COMMENCING THE WORKS.

- ALL WORK TO BE CARRIED OUT COMPETENT,
SKILLED & QUALIFIED TRADESPEOPLE HOLDING
CURRENT CERTIFICATION WITH THE REQUIRED
AUTHORY AUTHORITY.
- PROVIDE ALL MATERIALS, LABOUR & EQUIPMENT


NECESSARY TO COMPLETE THE WORK AS PER THE DRAWING SET & ASSOCIATED DOCUMENTATION. - GRADE FINISHED GROUND LINE TO GIVE FALLS AWAY FROM BUILDINGS.

\_ISSUED FOR\_ **DEVELOPMENT APPLICATION NOT FOR CONSTRUCTION** 

PROJECT TITLE DRAWING AMENDMENTS **REX ST GROUP HOME** +L TIM LEE PROPOSED SITE PLAN - ROOF LEVEL 12/24 TL **▲ ARCHITECTS** REVISION DESCRIPTION DATE CHENT DEVELOPMENT APPLICATION DOUBLE SKULL PTY LTD P: 02 4822 5934 AΗ As indicated LOT 83 DP 10309 ROSS PLACE Figured dimensions take precedence. Do not scale drawings GOULBURN NSW A3 SHEET Builder to check all levels datum and dimensions on the job, conflicting information to be resolved by the project manager prior to 1024-1723 2580 commencing work. All materials and workmanship to be in restrict accordance with current Australian standards, BCA, Local regulation NOMINATED ARCHITECT and manufacturers current printed instructions. Unless noted otherwise use only best quality materials, fittings and fixtures. DRAWING IDENTIFICATION NUMBER AMENDMENT ISSUE COPYRIGHT TIM LEE ARCHITECTS 7 REX STREET GOULBURN NSW REG: 7304 Drawings subject to copyright and may not be reproduced in any form without the written permission of the architect A-05

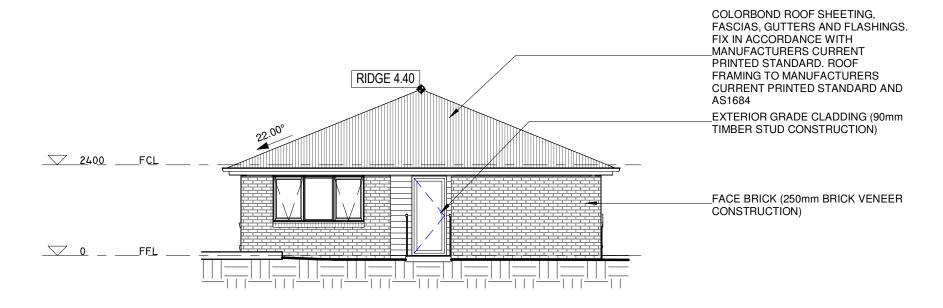


ACCESSIBLE UNIT SOUTH ELEVATION
1:100 @ A3

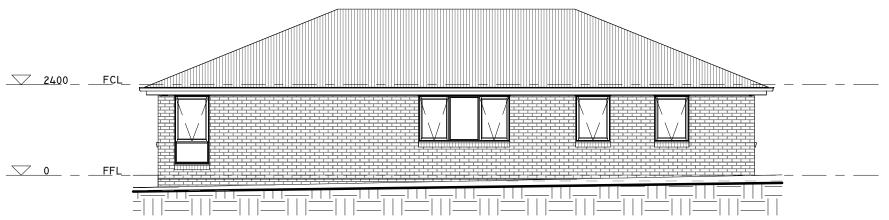

ACCESSIBLE UNIT WEST ELEVATION
1:100 @ A3

	DRAWING AMENDMENTS				DRAWING TITLE	ACCESSIBLE UNIT ELEVATIONS	12/24	DRAWING VERIFIED BY
REVISION	DESCRIPTION DEVELOPMENT APPLICATION		DOUBLE SKULL PTY LTD  P: 02 4822 5934 ABN: 7142506753	residential commercial industrial P: 02 4822 5934 ABN: 71425067537	LOT AND DEPOSITED PLAN NO.	TED PLAN NO.  LOT 83 DP 10309	DRAWING SCALE  1:100	DRAWN BY
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## TYPICAL UNIT EAST ELEVATION

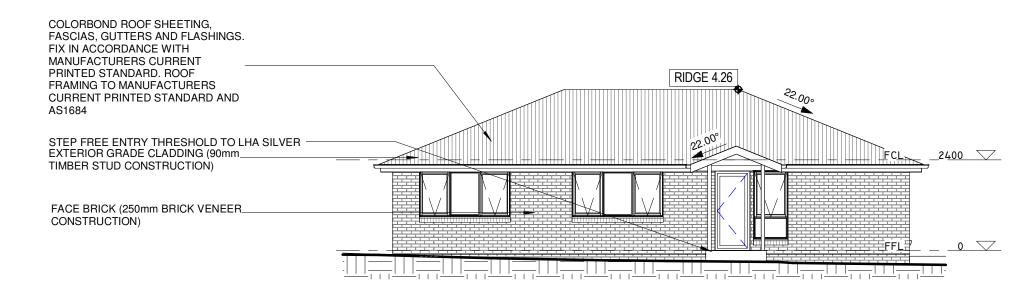1:100@A3





<u>2</u>

### TYPICAL UNIT NORTH ELEVATION

1:100@A3


DRAWING AMENDMENTS REVISION DESCRIPTION DATE		DATE	REX ST GROUP HOME	+L TIM LEE  ▲ ARCHITECTS	DRAWING TITLE	TYPICAL UNIT ELEVATIONS	12/24	DRAWING VERIFIED BY
A	EVISION DESCRIPTION DATE 23/05/2025 CLIENT	DOUBLE SKULL PTY LTD	residential commercial industrial P: 02 4822 5934 ABN: 71425067537	LOT AND DEPOSITED PLAN NO.		DRAWING SCALE  1:100	DRAWN BY	
			Figured dimensions take precedence. Do not scale drawings.  Builder to check all levels datum and dimensions on the job, conflicting information to be resolved by the project manager prior to commencing work. All materials and workmanship to be in restrict accordance with current Australian standards, BCA, Local regulation	ROSS PLACE GOULBURN NSW 2580 NOMINATED ARCHITECT:		FO1 92 DF 10209	A3 SHEET	1024-1723
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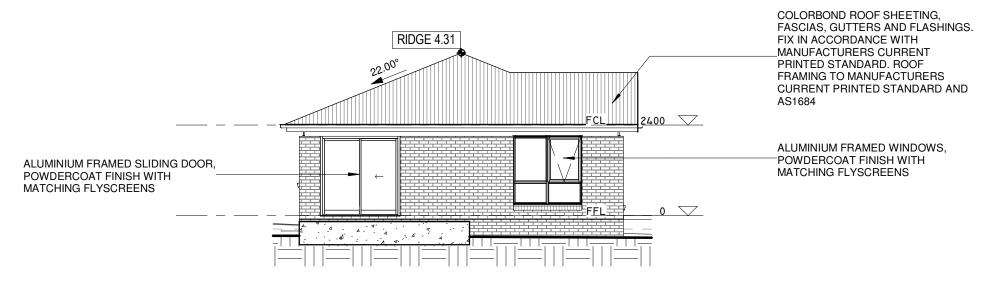


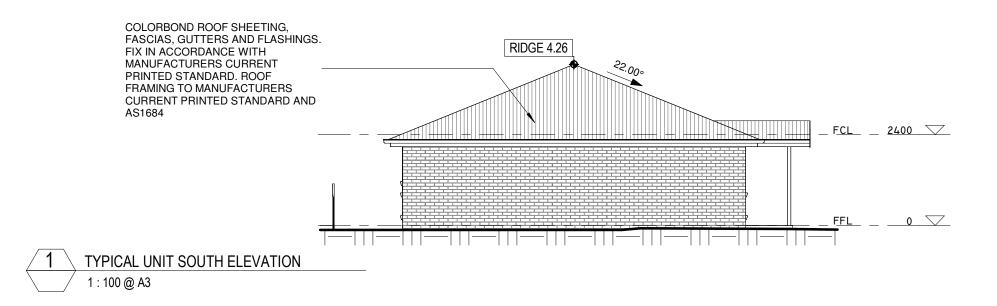

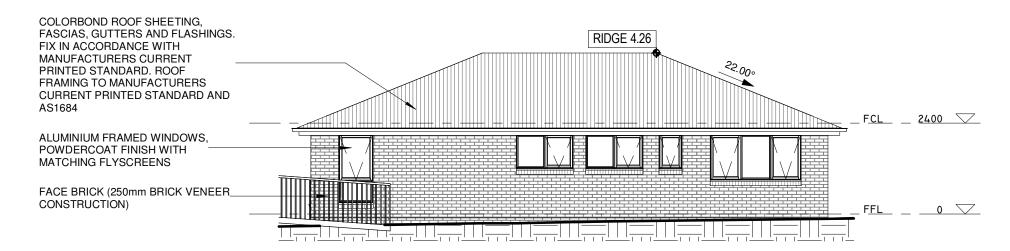


DRAWING AMENDMENTS		DATE	PROJECT TITLE REX ST GROUP HOME	+L TIM LEE  ▲ ARCHITECTS	DRAWING TITLE	TYPICAL UNIT ELEVATIONS	DRAWING COMMENCED 12/24	DRAWING VERIFIED BY
A	REVISION DESCRIPTION DATE  A DEVELOPMENT APPLICATION 23:05:2025	DOUBLE SKULL PTY LTD	residential commercial industrial P: 02 4822 5934 ABN: 71425067537	LOT 83 DP 10309	DRAWING SCALE  1:100	DRAWN BY		
			Figured dimensions take precedence. Do not scale drawings.  Builder to check all levels datum and dimensions on the job, conflicting information to be resolved by the project manager prior to commencing work. All materials and workmanship to be in restrict accordance with current Australian standards, BCA, Local regulations.	ROSS PLACE GOULBURN NSW 2580 NOMINATED ARCHITECT:		LOT 63 DF 10309	AT SHEET SIZE  A3 SHEET	JOB NUMBER 1024-1723
			and manufacturers current printed instructions. Unless noted otherwise use only best quality materials, fittings and fixtures.  COPYRIGHT TIM LEE ARCHITECTS  Drawings subject to copyright and may not be reproduced in any form without the written permission of the architect.	TIM LEE NSW REG: 7304 ACT REG: 1030	STREET ADDRESS	7 REX STREET GOULBURN	DRAWING IDENTIFICATION NUMBER  A-12	AMENDMENT ISSUE




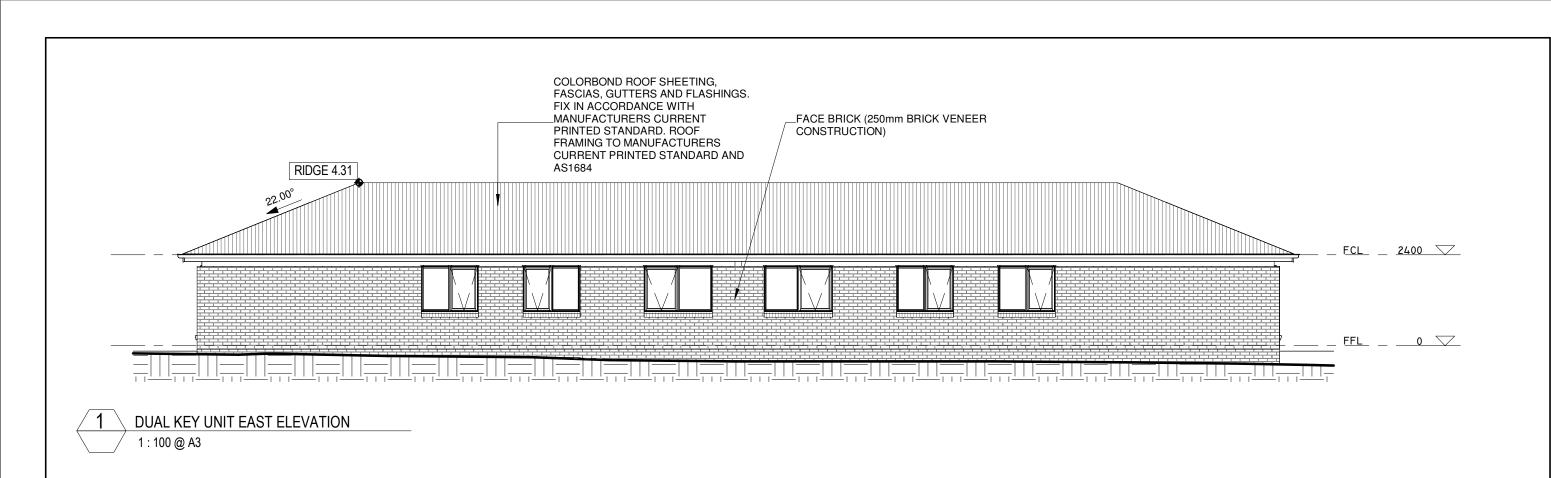

DUAL KEY UNIT NORTH ELEVATION
1:100 @ A3

DRAWING AMENDMENTS		DATE	PROJECT TITLE REX ST GROUP HOME	+L TIM LEE ARCHITECTS	DRAWING TITLE	DUAL KEY UNIT ELEVATIONS	DRAWING COMMENCED 12/24	DRAWING VERIFIED BY
	DATE 23/05/2025	DOUBLE SKULL PTY LTD	residential commercial industria P: 02 4822 5934 ABN: 71425067537	LOT AND DEPOSITED PLAN NO.	LOT 83 DP 10309		DRAWN BY	
			Figured dimensions take precedence. Do not scale drawings.  Builder to check all levels datum and dimensions on the job, conflicting information to be resolved by the project manager prior to commencing work. All materials and workmanship to be in restrict accordance with current Australian standards, BCA, Local regulation	ROSS PLACE GOULBURN NSW 2580 NOMINATED ARCHITECT:	EOT 63 DI 10309		A3 SHEET	JOB NUMBER 1024-1723
			and manufacturers current printed instructions. Unless noted otherwise use only best quality materials, fittings and fixtures.  COPYRIGHT TIM LEE ARCHITECTS  Drawings subject to copyright and may not be reproduced in any form without the written permission of the architect.	TIM LEE  NSW REG: 7304  ACT REG: 1030	STREET ADDRESS	7 REX STREET GOULBURN	DRAWING IDENTIFICATION NUMBER A-13	AMENDMENT ISSUE

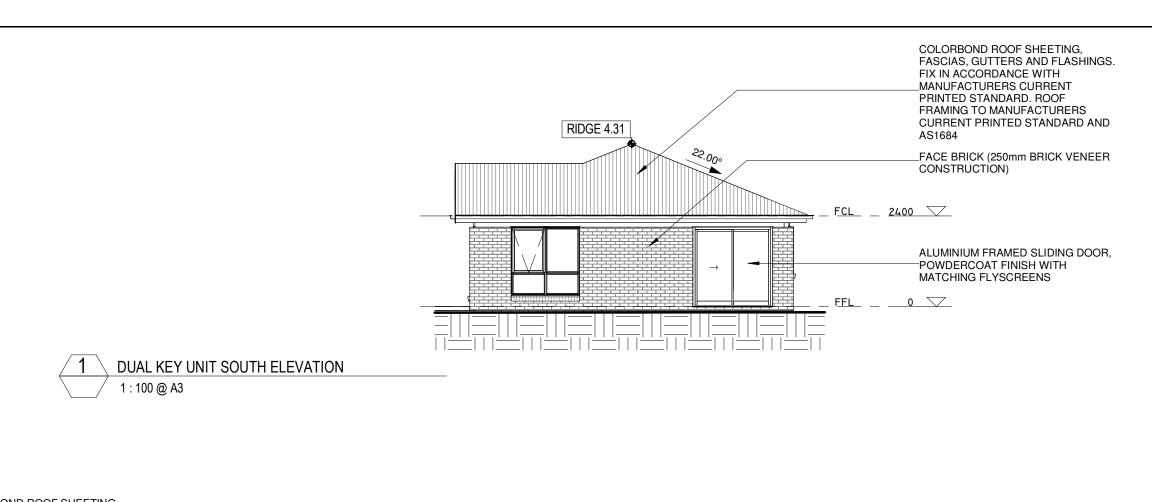

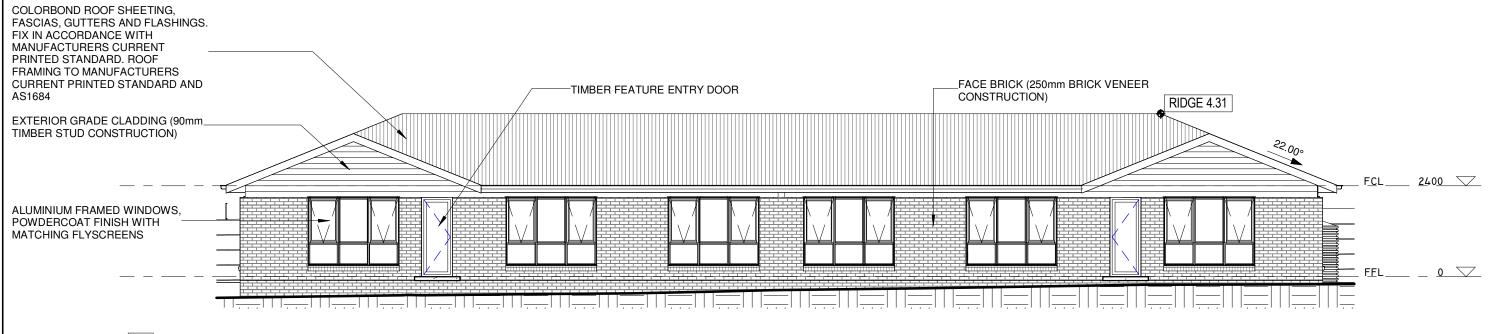

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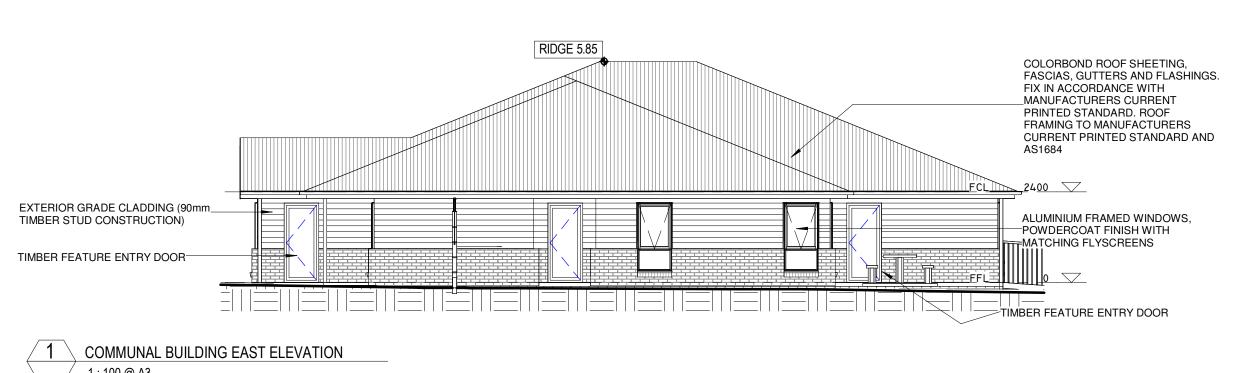
1024-1723

AMENDMENT ISSUE


DRAWING A	DRAWING AMENDMENTS		REX ST GROUP HOME	+L TIM LEE	DUAL KEY UNIT ELEVATIONS	DRAWING COMMENCED
REVISION	DESCRIPTION	DATE		<b>▲</b> ARCHITECTS	BONENET ONLY ELEVATIONS	12/24
REVISION	DESCRIPTION  DEVELOPMENT APPLICATION	23/05/2025	CUENT DOLLDIE OKULL DTV. LTD	residential commercial industrial	LOT AND DEPOSITED PLAN NO.	DRAWING SCALE
			DOUBLE SKULL PTY LTD	P: 02 4822 5934 ABN: 71425067537	LOT 83 DP 10309	1:100
			Figured dimensions take precedence. Do not scale drawings.	ROSS PLACE GOULBURN NSW	LOT 03 DF 10309	AT SHEET SIZE
			Builder to check all levels datum and dimensions on the job, conflicting information to be resolved by the project manager prior to commencing work. All materials and workmanship to be in restrict accordance with current Australian standards, BCA, Local regulation	2580  NOMINATED ARCHITECT:		A3 SHEET
			and manufacturers current printed instructions. Unless noted otherwise use only best quality materials, fittings and fixtures.  COPYRIGHT TIM LEE ARCHITECTS  Drawings subject to copyright and may not be reproduced in any form without the written permission of the architect.	TIM LEE NSW REG: 7304	7 REX STREET GOULBURN	DRAWING IDENTIFICATION NUMBER  A-14

DUAL KEY UNIT WEST ELEVATION

1:100@A3



1:100@A3

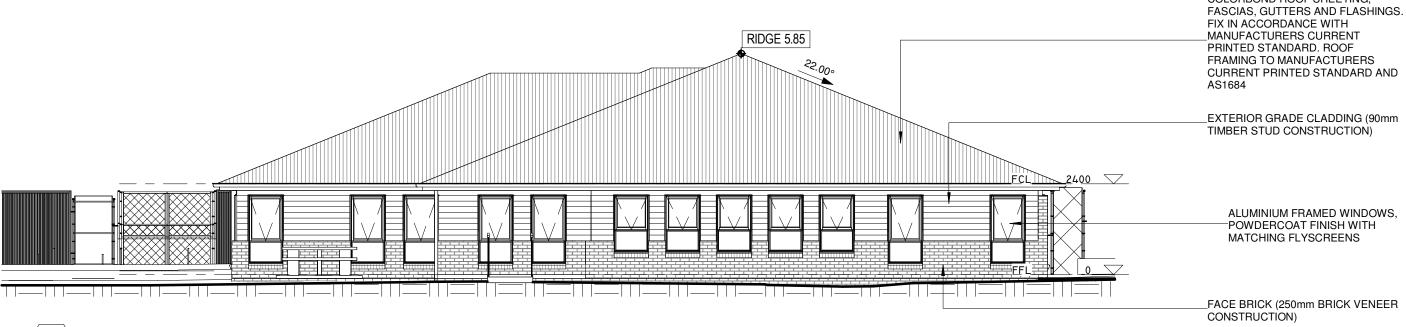

COMMUNAL BUILDING NORTH ELEVATION

1:100@A3

\_ISSUED FOR\_ DEVELOPMENT APPLICATION **NOT FOR CONSTRUCTION** 

COLORBOND ROOF SHEETING,

	DRAWING AMENDMENTS		REX ST GROUP HOME		DRAWING TITLE	COMMUNAL BUILDING ELEVATIONS	DRAWING COMMENCED 12/24	DRAWING VERIFIED BY
REVISION	REVISION DESCRIPTION DATE  A DEVELOPMENT APPLICATION 23/05/202	23/05/2025	DOUBLE SKULL PTY LTD	residential commercial industrial P: 02 4822 5934 ABN: 71425067537	LOT AND DEPOSITED PLAN NO.  LOT 83 DP 10309	DRAWING SCALE  1:100	DRAWN BY AH	
			Figured dimensions take precedence. Do not scale drawings.  Builder to check all levels datum and dimensions on the job, conflicting information to be resolved by the project manager prior to commencing work. All materials and workmanship to be in restrict accordance with current Australian standards, BCA, Local regulation and manufacturers current printed instructions. Unless noted otherwise use only best quality materials, fittings and fixtures.  COPYRIGHT TIM LEE ARCHITECTS  Drawings subject to copyright and may not be reproduced in any form without the written permission of the architect.			LOT 65 DF 10309	A3 SHEET	1024-1723
					STREET ADDRESS	7 REX STREET GOULBURN	DRAWING IDENTIFICATION NUMBER  A-16	AMENDMENT ISSUE






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COMMUNAL BUILDING SOUTH ELEVATION

1:100@A3

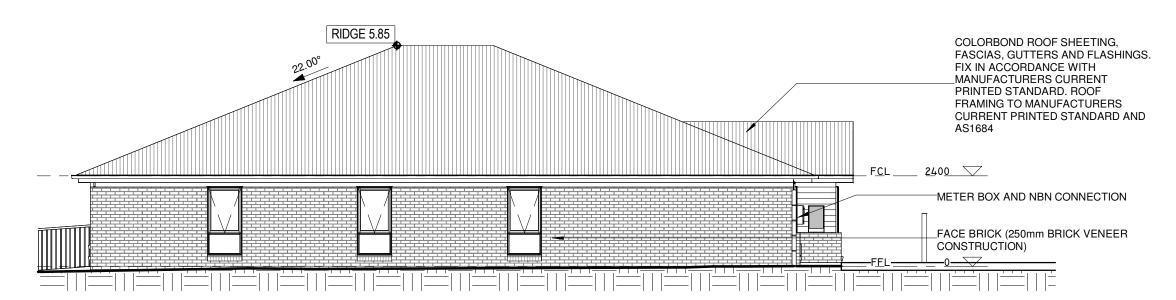


**2** 

COMMUNAL BUILDING WEST ELEVATION

1:100@A3

DRAWING	DRAWING AMENDMENTS		REX ST GROUP HOME	<b>+L</b> TIM LEE □	COMMUNAL BUILDING ELEVATIONS	12/24	TI
REVISION A	DESCRIPTION DEVELOPMENT APPLICATION	DEVELOPMENT APPLICATION  23/05/2025  DOUBLE SKULL PTY LTD  P: 02 4822 5934 ABN: 71425067537		LOT AND DEPOSITED PLAN NO.  LOT 83 DP 10309	DRAWING SCALE  1:100	DRAWN BY	
		Figured dimensions take precedence. Do not scale drawings.  Builder to check all levels datum and dimensions on the job, conflicting information to be resolved by the project manager prior to commencing work. All materials and workmanship to be in restrict accordance with current Australian standards, BCA, Local regulation	ROSS PLACE GOULBURN NSW 2580 NOMINATED ARCHITECT:	EOT 63 DI 10309	A3 SHEET	1024-1723	
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#### **GENERAL NOTES:**

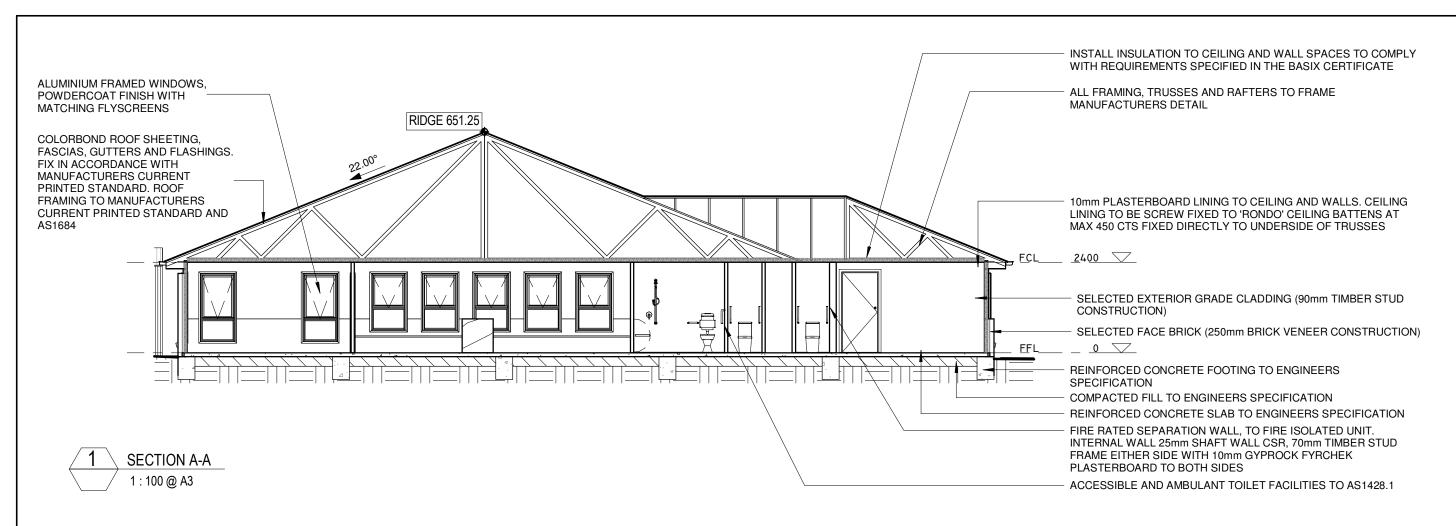PROVIDE TERMITE CONTROL TO ALL AREAS AS REQUIRED BY PART B OF THE BCA, AS 3660.1 & 3660.2

INSTALL HARD WIRED SMOKE ALARMS TO AS 3786 ADJACENT TO SLEEPING AREAS AS DIRECTED ONSITE.

ALL WALLS TO BE FULLY SARKED, CSR BRADFORD WALLWRAP XP OR EQUAL.

RANGE HOODS EXHAUST SYSTEMS TO HAVE A MINIMUM FLOW RATE OF 40L/s. MINIMUM BEARING PRESSURE 150KPa. ONO.

EXHAUSTS FROM BATHROOMS & LAUNDRY MUST BE DISCHARGED DIRECTLY OR VIA A SHAFT OR DUCT TO OUTSIDE AIR. MECHANICAL VENTILATION & LIGHTING TO MEET PART F4 OF THE BCA. INSTALL TO MANUFACTURER'S CURRENT PRINTED INSTRUCTIONS.

CONNECT ALL NEW DOWNPIPES TO NEW WATER TANKS, OVERFLOW TO STORMWATER SYSTEM

CONNECT ALL NEW DOWNPIPES TO NEW WATER TANKS, OVERFLOW TO STORMWATER SYSTEM.

#### EXTERNAL STAIRS

NON-SLIP PRECAST STEPS TO BE 75mm THICK ALL STEPS TO HAVE NON-SLIP GROOVES TO THE FRONT EDGE. ALL STEPS TO BE IN ONE PIECE FOR ITS FULL LENGTH. STAIR RISE AND GOING TO COMPLY WITH BCA D2.13 - 2R+G: GREATER THAN 550mm LESS THAN 700mm. ALL STAIR RISERS TO BE EQUAL AND COMPLY WITH BCA D2.13 - MIN. 115mm AND MAX. 190mm. MAXIMUM VARIANCE ACROSS THE STAIR LENGTH ±2mm. ALL STAIR GOINGS TO BE EQUAL TO AND COMPLY WITH BCA D2.13 - MIN. 240mm (PRIVATE), MIN. 250mm (PUBLIC) AND MAX. 355mm

#### **CONCRETE SLABS & FOUNDATIONS**

ALL SUB-GRADE & COMPACTED FILL BELOW SLAB TO APPROVAL USING APPROVED GRANULAR MATERIAL COMPACTED TO 98% OF STANDARD DRY DENSITY. ALL FOOTINGS DOWN TO SOLID FOUNDATIONS WITH MIN. 150KPa. OR A APPROVED BY ENGINEER SITE INSPECTION PRIOR TO CONCRETE POUR. - A JAS-ANZ ACCREDITED 3RD PARTY PROCESSOR CERTIFICATE (ACRS OR EQUIVALENT) MUST BE SUPPLIED WITH ALL STEEL REINFORCEMENT AT PROCUREMENT, BEFORE ANY CONCRETE IS PLACED, TO GUARANTEE CONFORMANCE OF THE REINFORCEMENT TO AS/NZS 4671.

FILL & FILL COMPACTION TO ENGINEER'S DETAILS.

50mm SET DOWN FOR THRESHOLD AT ROLLER DOOR OPENING.

50mm SET DOWN FOR WET AREAS.

TIMBER FRAME BRACING, TIE-DOWNS & JOINT SCHEDULE TO BE DESIGNED & CERTIFIED BY THE FRAME FABRICATOR IN ACCORDANCE WITH AS1684 (NATIONAL TIMBER FRAMING CODE)

#### **CEILINGS**

10mm PLASTERBOARD CEILING LINING SCREW FIXED TO 'RONDO' CEILING BATTENS AT 450cts. 'RONDO' CEILING BATTENS NAILED TO UNDERSIDE OF TRUSSES OR JOISTS . INSTALL AL FITTINGS & FIXTURES TO MANUFACTURER'S CURRENT PRINTED INSTRUCTIONS, 90mm STANDARD PROFILE PLASTERBOARD CORNICE.

#### WALLS

INTERNAL WALLS GENERALLY TO BE 10mm PLASTERBOARD OVER 90x45 (LOADBEARING WALL) OR 90x35 (NON LOADBEARING WALLS) MGP10 F5 STUD AT 450cts. USE 6mm VILLABOARD TO WET AREAS.

#### **EXTERIOR WALLS - MASONRY**

WEEPHOLES TO EVERY THIRD PERPEND. SUPER ALCOR DCP OVER

FORM 12mm EJ TO EACH BRICK SKIN WITH 50mm ABELFLEX STRIP. FILL JOINT WITH POLYETHYLENE FOAM BACKING ROD & SEAL WITH COLOURED MASTIC. EJ AT MAX. 9m cts UNLESS OTHERWISE SPECIFIED. SLIP JOINT BETWEEN CONCRETE SLAB & SUPPORTING MASONRY WALLS. CLEAR ALL PERPENDS TO LOWEST COURSE

#### **EXTERIOR WALLS - CLADDING**

SELECTED EXTERIOR GRADE CLADDING OVER ENVIROSEAL OR BRADFORD WALLWRAP XP (BAL RATED), FIX INTERNAL LINING OVER INSULATION (REFER TO BASIX / NATHERS REQUIREMENTS) & SISALATION, SELECTED COLOUR. EXTERIOR PAINT TO A LEVEL 4 PAINT FINISH. INSTALL TO MANUFACTURER'S CURRENT PRINTED INSTRUCTIONS.

#### ROOF

SELECTED PROFILED SHEET STEEL ROOFING (COLORBOND FINISH), COLORBOND FASCIAS, GUTTERS & FLASHINGS. FIX IN ACCORDANCE WITH MANUFACTURER'S CURRENT PRINTED INSTRUCTIONS, ROOF FRAMING & ROOF BATTTENS TO AS1684.

#### **WET AREAS**

WET AREAS SHOWN HATCHED, LAY SELECTED NON-SLIP CERAMIC TILES TO EQUAL R11 / P4 ON MORTAR BED GRADED TO GIVE FALLS TO FW'S AS SHOWN. AREAS TO BE TREATED IN ACCORDANCE WITH AUSTRALIAN STANDARDS AS 3740 WATERPROOFING OF WET AREAS WITHIN RESIDENTIAL BUILDINGS.

THE WATERPROOFING SYSTEM TO BE APPROPRIATE FOR THE BASE CONSTRUCTION. DO NOT WATERPROOF OVER PARTICLE BOARD OR TIMBER

PROVIDE EVIDENCE OF MANUFACTURER'S PRODUCT INSTALLATION DATA SHEETS & REQUIREMENTS.

INSTALL ALL PRODUCTS TO MANUFACTURER'S CURRENT PRINTED INSTRUCTIONS

TILING TO BE COMPLETED WITH NO RAISED EDGES OR TIGHT JOINTS.

APPROPRIATE TRIMS & FINISH BEADS TO BE INSTALLED.


SUB-STANDARD TILING WILL BE REJECTED, REJECTED WORK TO BE REMOVED. BASE WORK IS TO BE REPREPARED & NEW MATCHING MATERIALS SUPPLIED & LAID AT CONTRACTOR'S EXPENSE.


REFER TO COMPLIANCE NOTE SHEET FOR GENERAL NOTES.


—ISSUED FOR— **DEVELOPMENT APPLICATION** NOT FOR CONSTRUCTION


#### PROJECT TITLE DRAWING AMENDMENTS **REX ST GROUP HOME** +L TIN AR REVISION DESCRIPTION DATE CLIENT DEVELOPMENT APPLICATION DOUBLE SKULL PTY LTD Figured dimensions take precedence. Do not scale drawings Builder to check all levels datum and dimensions on the job, conflicting information to be resolved by the project manager prior to commencing work. All materials and workmanship to be in restrict accordance with current Australian standards, BCA, Local regulation urers current printed instructions. Unless noted otherwise use only best quality materials, fittings and fixtures. COPYRIGHT TIM LEE ARCHITECTS Drawings subject to copyright and may not be reproduced in any form without the written permission of the architect


	DRAWING TITLE		DRAWING COMMENCED	DRAWING VERIFIED BY
ARCHITECTS		SECTION A-A	12/24	TL
residential commercial industrial	LOT AND DEPOSITED PLAN NO.		DRAWING SCALE	DRAWN BY
P: 02 4822 5934 ABN: 71425067537		LOT 83 DP 10309	1:100	AH
ROSS PLACE GOULBURN NSW		LOT 65 DI 10509	AT SHEET SIZE	JOB NUMBER
2580  NOMINATED ARCHITECT:			A3 SHEET	1024-1723
TIM LEE	STREET ADDRESS		DRAWING IDENTIFICATION NUMBER	AMENDMENT ISSUE
NSW REG: 7304 ACT REG: 1030		7 REX STREET GOULBURN	A-18	А

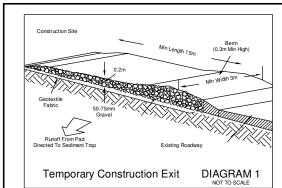


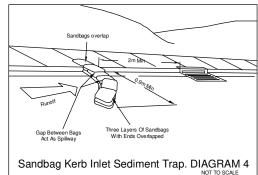

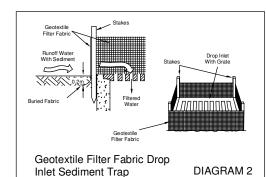

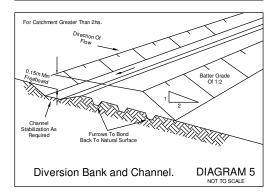

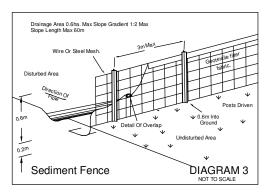

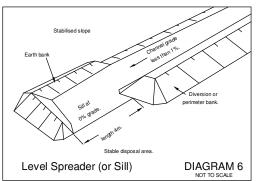

### **GENERAL NOTES:**

12.

- ALL WORK TO COMPLY WITH THE REQUIREMENTS OF COUNCIL & DEPT OF HOUSING MANUAL "MANAGING URBAN
- 2.
- STORMWATER SOILS & CONSTRUCTION"


  ALL DISTURBED AREAS ON VERGES & ALLOTMENTS SHALL BE RIPPED 100mm BELOW FINISHED SURFACE LEVEL,100mm OF
- APPROVED SITE OR IMPORTED TOPSOIL ADDED & TRIMMED TO FINISHED LEVEL. THEN GRASSED WITH APPROVED SEED/MULCHED WITHIN 14 DAYS AND WATERED UNTIL FULL ESTABLISHMENT OCCURS.

  ALL ADJOINING AREAS TO BE PROTECTED FROM SEDIMENT VIA SILT FENCE AS DETAILED. (IF FALL TO LAND OCCURS) ALL PROPOSED AND EXISTING KERB INLET SUMPS SHALL BE PROTECTED FROM SEDIMENT AS DETAILED. (GULLY PIT
- PROTECTION)

- PROTECTION)
  ALL SURFACE INLET PITS (OFF ROAD) SHALL BE PROTECTED FROM SEDIMENT AS DETAILED. (SURFACE INLET PITS)
  ALL PAVEMENT & SUBGRADES TO BE PROTECTED FROM SCOUR/EROSION AS DETAILED. (PAVEMENT PROTECTION)
  ALL OUTLET PIPE'S SHALL BE FITTED WITH STAKED STRAW BALLES & SILT FENCE IN A DAM PATTERN.
  ALL SWALE DRAINS (OPEN CHANNELS) TO BE TREATED AS PER PAVEMENT PROTECTION UNTIL GRASS IS ESTABLISHED.
  300mm WIDE STRIP. OF TURF TO BE LAID BEHIND KERB. 1m RETURNS AT 50m INTERVALS. TURF ALSO TO BE LAID AROUND ALL
- SURFACE INLET PITS.
- EXISTING GRASSED AREAS SHOWN ON SOIL AND WATER MANAGEMENT PLAN ARE TO BE MAINTAINED IN CURRENT CONDITION 10.
- WHERE EVER POSSIBLE WHERE EVER POSSIBLE
  TOPSOIL SHALL BE STRIPPED AND STOCKPILED OUTSIDE HAZARD AREAS SUCH AS DRAINAGE LINES. THIS TOPSOIL IS TO BE
  RESPREAD LATER ON AREAS TO BE REVEGETATED AND STABILISED ONLY. (ie: ALL FOOTPATHS, BATTERS, SITE REGRADING
  AREAS, DRAINAGE RESERVES AND CHANNELS.) TOPSOIL SHALL NOT BE RESPREAD ON ANY OTHER AREA UNLESS SPECIFICALLY
  INSTRUCTED BY THE SUPERINTENDENT. IF THEY ARE TO REMAIN FOR LONGER THAN ONE MONTH STOCKPILES SHALL BE
  PROTECTED FROM EROSION BY COVERING THEM WITH A MULCH AND HYDROSEEDING AND, IF NECESSARY, BY LOCATING
  BANKS OR DRAINS UPSLOPE TO DIVERT THE RUNOFF AROUND THEM. IN SOME CIRCUMSTANCES IT MAY BE NECESSARY TO
  PLACE BANKS OR DRAINS DOWNSTREAM OF A STOCKPILE TO RETARD SEDIMENT LADEN RUNOFF.
  - THE CONTRACTOR SHALL REGULARLY MAINTAIN ALL SEDIMENT AND EROSION CONTROL DEVICES AND REMOVE ACCUMULATED SILT FROM SUCH DEVICES BEFORE NO MORE THAN 60% OF THEIR CAPACITY IS LOST. ALL THE SILT REMOVED SHALL BE DISPOSED OF AS DIRECTED BY THE SUPERINTENDENT. NO SILT IS TO BE PLACED OUTSIDE THE LIMIT OF WORKS. THE PERIOD FOR MAINTAINING THESE DEVICES SHALL BE AT LEAST UNTILL ALL DISTURBED AREAS ARE REVEGETATED AND FURTHER AS MAY BE DIRECTED BY THE SUPERINTENDENT OR COUNCIL.
- VEHICULAR TRAFFIG SHALL BE CONTROLLED DURING CONSTRUCTION CONFINING ACCESS WHERE POSSIBLE TO PROPOSED OR EXISTING ROAD ALIGNMENTS. 13.
- OR EXISTING HOAD ALIGNMENTS.

  THE CONTRACTOR SHALL MAINTAIN DUST CONTROL UNTIL FINAL COMPLETION OF WORKS.

  THE CONTRACTOR'S RESPONSIBILITY IS TO ENSURE ALL NECESSARY MEASURES ARE TAKEN TO PROTECT ALL DISTURBED AREAS AS PER NOTE 1. ALL ADDITIONAL COSTS IS TO BE REFLECTED IN TENDER PRICE EVEN IF SUCH MEASURES ARE NOT INDICATED ON SEDIMENT AND EROSION CONTROL PLANS.

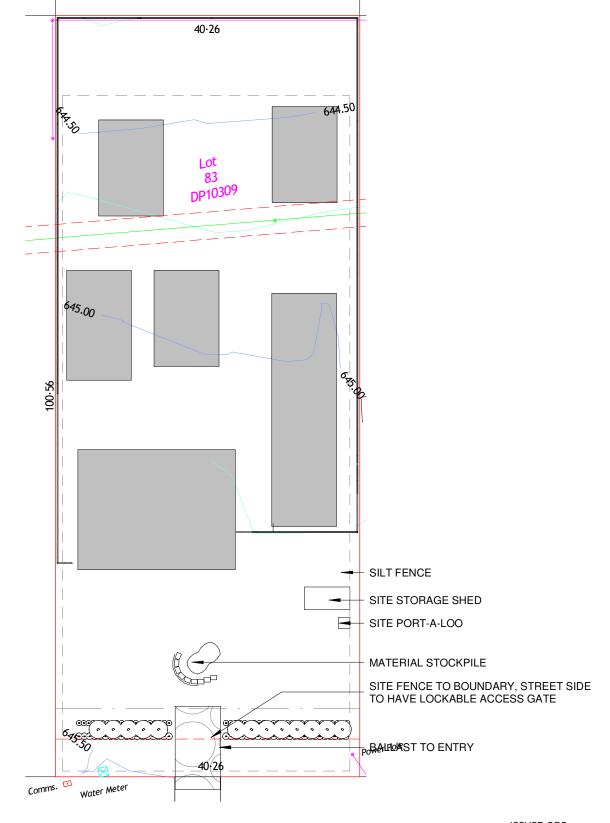





## \_ISSUED FOR\_ **DEVELOPMENT APPLICATION NOT FOR CONSTRUCTION**

DRAWING	AMENDMENTS		REX ST GROUP HOME	+1			
REVISION A	DESCRIPTION DEVELOPMENT APPLICATION	DATE 23/05/2025	DOUBLE SKULL PTY LTD				
			Figured dimensions take precedence. Do not scale drawings.  Builder to check all levels datum and dimensions on the job, conflicting information to be resolved by the project manager prior to commencing work. All materials and workmanship to be in restrict accordance with current Australian standards, BCA, Local regulation and manufacturers current printed instructions. Unless noted otherwise use only best quality materials, fittings and fixtures.  COPYRIGHT TIM LEE ARCHITECTS  Drawings subject to copyright and may not be reproduced in any form without the written permission of the architect.	)			

L TIM LEE	DRAWING TITLE	EROSION CONTROL NOTES & PLAN	DRAWING COMMENCED 12/24	DRAWING VERIFIED BY
residential commercial industrial P: 02 4822 5934 ABN: 71425067537	LOT AND DEPOSITED PLAN NO.	LOT 83 DP 10309	As indicated	DRAWN BY
ROSS PLACE GOULBURN NSW 2580 NOMINATED ARCHITECT:		LOT 65 DI 16563	A3 SHEET	1024-1723
TIM LEE  NSW REG: 7304  ACT REG: 1030	I LEE STREET ADDRESS EG: 7304	7 REX STREET GOULBURN	DRAWING IDENTIFICATION NUMBER  A-19	AMENDMENT ISSUE

	DOOR SCHEDULE					DOOR SCHEDULE						
DOOR NO.	DOOR TYPE	HEIGHT	WIDTH	SILL HEIGHT	HEAD HEIGHT	DOOR NO.	DOOR TYPE	HEIGHT	WIDTH	SILL HEIGHT	HEAD HEIGH	
101	STEEL FRAMED LIETZKE SECURITY DOOR	2100	920	0	2100	306	TIMBER FRAMED, SOLID CORE SWINGING DOOR	2100	820	0	2100	
102	ALUMINIUM FRAMED SLIDING DOOR, POWDERCOAT FINISH WITH	2100	3600	0	2100	307	TIMBER FRAMED SLIDING ROBE	2040	3300	0	2040	
	MATCHING FLYSCREENS					307	TIMBER FRAMED SLIDING ROBE	2040	3300	0	2040	
03	TIMBER FRAMED, SOLID CORE SWINGING DOOR	2100	920	0	2100	307	TIMBER FRAMED SLIDING ROBE	2040	3300	0	2040	
04	TIMBER FRAMED SLIDING ROBE	2040	3400	0	2040	308	TIMBER FRAMED, SOLID CORE SWINGING DOOR	2100	820	0	2100	
)5	TIMBER FRAMED, SOLID CORE SWINGING DOOR	2100	920	0	2100	308	TIMBER FRAMED, SOLID CORE SWINGING DOOR	2100	820	0	2100	
)6	TIMBER FRAMED SLIDING ROBE	2040	3400	0	2040	308	TIMBER FRAMED, SOLID CORE SWINGING DOOR	2100	820	0	2100	
)7	TIMBER FRAMED, SOLID CORE SWINGING DOOR	2100	920	0	2100	309	TIMBER FRAMED, SOLID CORE SWINGING DOOR	2100	820	0	2100	
18	TIMBER FRAMED, SOLID CORE SWINGING DOOR	2100	920	0	2100	309	TIMBER FRAMED, SOLID CORE SWINGING DOOR	2100	820	0	2100	
)9	TIMBER FRAMED SLIDING ROBE	2040	3400	0	2040	309	TIMBER FRAMED, SOLID CORE SWINGING DOOR	2100	820	0	2100	
10	TIMBER FRAMED, SOLID CORE SWINGING DOOR	2100	920	0	2100	310	TIMBER FRAMED, SOLID CORE SWINGING DOOR	2100	820	0	2100	
)1	STEEL FRAMED LIETZKE SECURITY DOOR	2100	820	0	2100	310	TIMBER FRAMED, SOLID CORE SWINGING DOOR	2100	820	0	2100	
2	ALUMINIUM FRAMED SLIDING DOOR, POWDERCOAT FINISH WITH	2100	2100	0	2100	310	TIMBER FRAMED, SOLID CORE SWINGING DOOR	2100	820	0	2100	
	MATCHING FLYSCREENS					311	TIMBER FRAMED SLIDING ROBE	2040	2000	0	2040	
5	ALUMINIUM FRAMED SLIDING DOOR, POWDERCOAT FINISH WITH	2100	2100	0	2100	311	TIMBER FRAMED SLIDING ROBE	2040	2000	0	2040	
	MATCHING FLYSCREENS			_		311	TIMBER FRAMED SLIDING ROBE	2040	2000	0	2040	
3	STEEL FRAMED LIETZKE SECURITY DOOR	2100	820	0	2100	312	TIMBER FRAMED, SOLID CORE SWINGING DOOR	2100	820	0	2100	
7	TIMBER FRAMED, SOLID CORE SWINGING DOOR	2100	820	0	2100	312	TIMBER FRAMED, SOLID CORE SWINGING DOOR	2100	820	0	2100	
3	TIMBER FRAMED, SOLID CORE SWINGING DOOR	2100	820	0	2100	312	TIMBER FRAMED, SOLID CORE SWINGING DOOR	2100	820	0	2100	
9	TIMBER FRAMED, SOLID CORE SWINGING DOOR	2100	820	0	2100	313	TIMBER FRAMED SLIDING ROBE	2040	2000	0	2040	
)	TIMBER FRAMED SLIDING ROBE	2040	3300	0	2040	313	TIMBER FRAMED SLIDING ROBE	2040	2000	0	2040	
1	TIMBER FRAMED, SOLID CORE SWINGING DOOR	2100	820	0	2100	313	TIMBER FRAMED SLIDING ROBE	2040	2000	0	2040	
2	TIMBER FRAMED SLIDING ROBE	2040	1800	0	2040	C1	STEEL FRAMED LIETZKE SECURITY DOOR	2100	920	0	2100	
3	TIMBER FRAMED, SOLID CORE SWINGING DOOR	2100	820	0	2100	C2	STEEL FRAMED LIETZKE SECURITY DOOR	2100	920	0	2100	
4	TIMBER FRAMED SLIDING ROBE	2040	2000	0	2040	- C3	STEEL FRAMED LIETZKE SECURITY DOOR	2100	920	0	2100	
5	SOLID CORE FIRE DOOR	2100	820	0	2100	C4	TIMBER FRAMED, SOLID CORE SWINGING DOOR	2100	920	0	2100	
6	TIMBER FRAMED, SOLID CORE SWINGING DOOR	2100	820	0	2100	C5	STEEL FRAMED SECUITY SHUTTER	1200	1700	900	2100	
7	TIMBER FRAMED, SOLID CORE SWINGING DOOR	2100	820	0	2100	C6	TIMBER FRAMED, SOLID CORE SWINGING DOOR	2100	920	0	2100	
3	TIMBER FRAMED, SOLID CORE SWINGING DOOR	2100	820	0	2100		TIMBER FRAMED, SOLID CORE SWINGING DOOR	2100	920	0	2100	
9	TIMBER FRAMED SLIDING ROBE	2040	3300	0	2040	C8	SOLID CORE FIRE SEPARATION DOOR	2100	920	0	2100	
0	TIMBER FRAMED, SOLID CORE SWINGING DOOR	2100	820	0	2100	C9	TIMBER FRAMED, SOLID CORE SWINGING DOOR	2100	920	0	2100	
1	TIMBER FRAMED SLIDING ROBE	2040	1800	0	2040	C10	TIMBER FRAMED, SOLID CORE SWINGING DOOR	2100	920	0	2100	
2	TIMBER FRAMED, SOLID CORE SWINGING DOOR	2100	820	0	2100	C11	TIMBER FRAMED, SOLID CORE SWINGING DOOR	2100	920	0	2100	
3	TIMBER FRAMED SLIDING ROBE	2040	2000	0	2040	C12	TIMBER FRAMED, HOLLOW CORE SWINGING DOOR	2100	720	0	2100	
4	SOLID CORE FIRE DOOR	2100	820	0	2100	C13	TIMBER FRAMED, HOLLOW CORE SWINGING DOOR	2100	720	0	2100	
1	STEEL FRAMED LIETZKE SECURITY DOOR	2100	920	0	2100	C14	TIMBER FRAMED. SOLID CORE SWINGING DOOR	2100	920	0	2100	
1	STEEL FRAMED LIETZKE SECURITY DOOR	2100	920	0	2100	C15	TIMBER FRAMED, SOLID CORE SWINGING DOOR	2100	920	0	2100	
1	STEEL FRAMED LIETZKE SECURITY DOOR	2100	920	0	2100	C16	TIMBER FRAMED OPENING - SIZE ON PLAN	0	0	0	0	
2	ALUMINIUM FRAMED SLIDING DOOR, POWDERCOAT FINISH WITH MATCHING FLYSCREENS	2100	2400	0	2100	C17	TIMBER FRAMED, SOLID CORE DOUBLE SWINGING DOOR	2040	1640	0	2040	
)2	ALUMINIUM FRAMED SLIDING DOOR, POWDERCOAT FINISH WITH	2100	2400	0	2100	C18	TIMBER FRAMED, SOLID CORE SWINGING DOOR	2100	920	0	2100	
_	MATCHING FLYSCREENS		55			C19	TIMBER FRAMED, SOLID CORE DOUBLE SWINGING DOOR	2040	1840	0	2040	
2	ALUMINIUM FRAMED SLIDING DOOR, POWDERCOAT FINISH WITH MATCHING FLYSCREENS	2100	2400	0	2100	C20	TIMBER FRAMED, SOLID CORE DOUBLE SWINGING DOOR	2040	1840	0	2040	
4	TIMBER FRAMED, SOLID CORE SWINGING DOOR	2100	820	0	2100	+						
	TIMBER FRAMED, SOLID CORE SWINGING DOOR	2100	820	0	2100	+						
4	TIMPER FRANCE, SOLID CORE SWINGING DOOR	2100	020	U	2100	_						

DRAWING	AMENDMENTS		PROJECT TITLE	REX ST GROUP HOME	+L TIM LEE	DRAWING TITLE	DOOR SCHEDULE	DRAWING COMMENCED	DRAWING VERIFIED BY
			1	NEX 31 GNOUP HOINE	ARCHITECTS		DOOR SCHEDULE	12/24	TL
REVISION		DATE 23/05/2025	CLIENT	DOUBLE OWN DEVILED	residential commercial industrial	LOT AND DEPOSITED PLAN NO.	T AND DEPOSITED PLAN NO.		DRAWN BY
				DOUBLE SKULL PTY LTD	P: 02 4822 5934 ABN: 71425067537 ROSS PLACE GOULBURN NSW  LOT 83 DP 10309		LOT 92 DD 10200		AH
			Figured dimensions tak	ke precedence. Do not scale drawings.		AT SHEET SIZE	JOB NUMBER		
		Builder to check all levels datum and dimensions on the job, conflicting information to be resolved by the project manager prior to commencing work. All materials and workmanship to be in restrict accordance with current Australian standards, BCA, Local regulation and manufacturers current printed instructions. Unless noted otherwise use only best quality materials, fittings and fixtures.  TIM LEF	2580			A3 SHEET	1024-172		
			STREET ADDRESS	REET ADDRESS		AMENDMENT ISSUE			
			COPYRIGHT TIM LEE ARCHITECTS  Drawings subject to copyright and may not be reproduced in any form without the written permission of the architect.		NSW REG: 7304 ACT REG: 1030		7 REX STREET GOULBURN	A-20	

TIMBER FRAMED, SOLID CORE SWINGING DOOR

	WINDOW SCHEDULE						WINDOW SCHEDULE				
WINDOW NO.	WINDOW TYPE	HEIGHT	WIDTH	SILL HEIGHT	HEAD HEIGHT	WINDOW NO.	WINDOW TYPE	HEIGHT	WIDTH	SILL HEIGHT	HEAD HEIGHT
101	ALUMINIUM FRAMED WINDOW, POWDERCOAT FINISH WITH MATCHING FLYSCREENS	1200	2410	900	2100	303	ALUMINIUM FRAMED WINDOW, POWDERCOAT FINISH WITH MATCHING FLYSCREENS	1200	2410	900	2100
102	ALUMINIUM FRAMED WINDOW, POWDERCOAT FINISH WITH MATCHING FLYSCREENS	1200	2410	900	2100	303	ALUMINIUM FRAMED WINDOW, POWDERCOAT FINISH WITH MATCHING FLYSCREENS	1200	2410	900	2100
103	ALUMINIUM FRAMED WINDOW, POWDERCOAT FINISH WITH MATCHING FLYSCREENS	1200	2410	900	2100	303	ALUMINIUM FRAMED WINDOW, POWDERCOAT FINISH WITH MATCHING FLYSCREENS	1200	2410	900	2100
104	ALUMINIUM FRAMED WINDOW, POWDERCOAT FINISH WITH MATCHING FLYSCREENS	1800	910	300	2100	304	ALUMINIUM FRAMED WINDOW, POWDERCOAT FINISH WITH MATCHING FLYSCREENS	1800	910	300	2100
105	ALUMINIUM FRAMED WINDOW, POWDERCOAT FINISH WITH MATCHING FLYSCREENS	1200	2410	900	2100	304	ALUMINIUM FRAMED WINDOW, POWDERCOAT FINISH WITH MATCHING FLYSCREENS	1800	910	300	2100
106	ALUMINIUM FRAMED WINDOW, POWDERCOAT FINISH WITH MATCHING FLYSCREENS	1800	910	300	2100	304	ALUMINIUM FRAMED WINDOW, POWDERCOAT FINISH WITH MATCHING FLYSCREENS	1800	910	300	2100
107	ALUMINIUM FRAMED WINDOW, POWDERCOAT FINISH WITH MATCHING FLYSCREENS	1200	2410	900	2100	305	ALUMINIUM FRAMED WINDOW, POWDERCOAT FINISH WITH MATCHING FLYSCREENS	1800	2410	300	2100
108	ALUMINIUM FRAMED WINDOW, POWDERCOAT FINISH WITH MATCHING FLYSCREENS	1200	910	900	2100	305	ALUMINIUM FRAMED WINDOW, POWDERCOAT FINISH WITH MATCHING FLYSCREENS	1800	2410	300	2100
109	ALUMINIUM FRAMED WINDOW, POWDERCOAT FINISH WITH MATCHING FLYSCREENS	1200	910	900	2100	305	ALUMINIUM FRAMED WINDOW, POWDERCOAT FINISH WITH MATCHING FLYSCREENS	1800	2410	300	2100
201	ALUMINIUM FRAMED WINDOW, POWDERCOAT FINISH WITH MATCHING FLYSCREENS	1800	2410	300	2100	306	ALUMINIUM FRAMED WINDOW, POWDERCOAT FINISH WITH MATCHING FLYSCREENS	1800	910	300	2100
202	ALUMINIUM FRAMED WINDOW, POWDERCOAT FINISH WITH MATCHING FLYSCREENS	1800	2410	300	2100	306	ALUMINIUM FRAMED WINDOW, POWDERCOAT FINISH WITH MATCHING FLYSCREENS	1800	910	300	2100
203	ALUMINIUM FRAMED WINDOW, POWDERCOAT FINISH WITH MATCHING FLYSCREENS	1800	2410	300	2100	306	ALUMINIUM FRAMED WINDOW, POWDERCOAT FINISH WITH MATCHING FLYSCREENS	1800	910	300	2100
204	ALUMINIUM FRAMED WINDOW, POWDERCOAT FINISH WITH MATCHING FLYSCREENS	1800	1810	300	2100	307	ALUMINIUM FRAMED WINDOW, POWDERCOAT FINISH WITH MATCHING FLYSCREENS	900	1510	1200	2100
205	ALUMINIUM FRAMED WINDOW, POWDERCOAT FINISH WITH MATCHING FLYSCREENS	1200	1510	900	2100	307	ALUMINIUM FRAMED WINDOW, POWDERCOAT FINISH WITH MATCHING FLYSCREENS	900	1510	1200	2100
206	ALUMINIUM FRAMED WINDOW, POWDERCOAT FINISH WITH MATCHING FLYSCREENS	1200	1810	900	2100	307	ALUMINIUM FRAMED WINDOW, POWDERCOAT FINISH WITH MATCHING FLYSCREENS	900	1510	1200	2100
207	ALUMINIUM FRAMED WINDOW, POWDERCOAT FINISH WITH MATCHING FLYSCREENS	1200	1810	900	2100		INFO INTO THE POST LEEPE				
208	ALUMINIUM FRAMED WINDOW, POWDERCOAT FINISH WITH MATCHING FLYSCREENS	1200	1510	900	2100						
209	ALUMINIUM FRAMED WINDOW, POWDERCOAT FINISH WITH MATCHING FLYSCREENS	1800	1810	300	2100						
210	ALUMINIUM FRAMED WINDOW, POWDERCOAT FINISH WITH MATCHING FLYSCREENS	1800	2410	300	2100						
211	ALUMINIUM FRAMED WINDOW, POWDERCOAT FINISH WITH MATCHING FLYSCREENS	1800	2410	300	2100						
212	ALUMINIUM FRAMED WINDOW, POWDERCOAT FINISH WITH MATCHING FLYSCREENS	1800	2410	300	2100						
213	ALUMINIUM FRAMED WINDOW, POWDERCOAT FINISH WITH MATCHING FLYSCREENS	1200	1510	900	2100						
214	ALUMINIUM FRAMED WINDOW, POWDERCOAT FINISH WITH MATCHING FLYSCREENS	1200	1510	900	2100						
201	ALLIMINIUM EDAMED WINDOW, DOWNEDCOAT FINISH WITH	1000	2410	000	2100	$\dashv$					

\_\_ISSUED FOR\_\_\_ DEVELOPMENT APPLICATION **NOT FOR CONSTRUCTION** 

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DRAWING	AMENDMENTS		REX ST GROUP HOME			
REVISION A	DESCRIPTION DEVELOPMENT APPLICATION	DATE 23/05/2025	DOUBLE SKULL PTY LTD	_		
			Figured dimensions take precedence. Do not scale drawings.  Builder to check all levels datum and dimensions on the job, conflicting information to be resolved by the project manager prior to commencing work. All materials and workmanship to be in restrict accordance with current Australian standards, BCA, Local regulation and manufacturers current printed instructions. Unless noted otherwise use only best quality materials, fittings and fixtures.  COPYRIGHT TIM LEE ARCHITECTS  Drawings subject to copyright and may not be reproduced in any form without the written permission of the architect.			

ACT REG: 1030

ALUMINIUM FRAMED WINDOW, POWDERCOAT FINISH WITH MATCHING FLYSCREENS

ALUMINIUM FRAMED WINDOW, POWDERCOAT FINISH WITH

ALUMINIUM FRAMED WINDOW, POWDERCOAT FINISH WITH MATCHING FLYSCREENS

MATCHING FLYSCREENS

MATCHING FLYSCREENS

MATCHING FLYSCREENS

MATCHING FLYSCREENS


+L TIM LEE	WINDOW SCHEDULE	DRAWING COMMENCED	DRAWING VERIFIED BY
residential commercial industrial P: 02 4822 5934 ABN: 71425067537 ROSS PLACE GOULBURN NSW 2580	LOT AND DEPOSITED PLAN NO.  LOT 83 DP 10309	DRAWING SCALE  AT SHEET SIZE  A3 SHEET	AH  JOB NUMBER  1024-1723
NOMINATED ARCHITECT: TIM LEE NSW REG: 7304 ACT REG: 1030	5TREET ADDRESS 7 REX STREET GOULBURN	DRAWING IDENTIFICATION NUMBER  A-21	AMENDMENT ISSUE

	WINDOW SCHEDULE						WINDOW SCHEDULE				
VINDOW NO.	WINDOW TYPE	HEIGHT	WIDTH	SILL HEIGHT	HEAD HEIGHT	WINDOW NO.	WINDOW TYPE	HEIGHT	WIDTH	SILL HEIGHT	HEAD HEIGH
	ALUMINIUM FRAMED WINDOW, POWDERCOAT FINISH WITH MATCHING FLYSCREENS	900	610	1200	2100	C13	ALUMINIUM FRAMED WINDOW, POWDERCOAT FINISH WITH MATCHING FLYSCREENS	1800	910	300	2100
	ALUMINIUM FRAMED WINDOW, POWDERCOAT FINISH WITH MATCHING FLYSCREENS	900	610	1200	2100	C14	ALUMINIUM FRAMED WINDOW, POWDERCOAT FINISH WITH MATCHING FLYSCREENS	1800	910	300	2100
	ALUMINIUM FRAMED WINDOW, POWDERCOAT FINISH WITH MATCHING FLYSCREENS	900	610	1200	2100	C15	ALUMINIUM FRAMED WINDOW, POWDERCOAT FINISH WITH MATCHING FLYSCREENS	1800	910	300	2100
	ALUMINIUM FRAMED WINDOW, POWDERCOAT FINISH WITH MATCHING FLYSCREENS	900	1510	1200	2100	C16	ALUMINIUM FRAMED WINDOW, POWDERCOAT FINISH WITH MATCHING FLYSCREENS	1800	910	300	2100
809	ALUMINIUM FRAMED WINDOW, POWDERCOAT FINISH WITH MATCHING FLYSCREENS	900	1510	1200	2100	C17	ALUMINIUM FRAMED WINDOW, POWDERCOAT FINISH WITH MATCHING FLYSCREENS	1800	910	300	2100
	ALUMINIUM FRAMED WINDOW, POWDERCOAT FINISH WITH MATCHING FLYSCREENS	900	1510	1200	2100	C18	ALUMINIUM FRAMED WINDOW, POWDERCOAT FINISH WITH MATCHING FLYSCREENS	1800	910	300	2100
:1	ALUMINIUM FRAMED WINDOW, POWDERCOAT FINISH WITH MATCHING FLYSCREENS	1800	910	300	2100	C19	ALUMINIUM FRAMED WINDOW, POWDERCOAT FINISH WITH MATCHING FLYSCREENS	1800	910	300	2100
2	ALUMINIUM FRAMED WINDOW, POWDERCOAT FINISH WITH MATCHING FLYSCREENS	1800	910	300	2100	C20	ALUMINIUM FRAMED WINDOW, POWDERCOAT FINISH WITH MATCHING FLYSCREENS	1800	910	300	2100
	ALUMINIUM FRAMED WINDOW, POWDERCOAT FINISH WITH MATCHING FLYSCREENS	1500	910	600	2100	C21	ALUMINIUM FRAMED WINDOW, POWDERCOAT FINISH WITH MATCHING FLYSCREENS	1800	910	300	2100
	ALUMINIUM FRAMED WINDOW, POWDERCOAT FINISH WITH MATCHING FLYSCREENS	1500	910	600	2100	C22	ALUMINIUM FRAMED WINDOW, POWDERCOAT FINISH WITH MATCHING FLYSCREENS	1800	910	300	2100
	ALUMINIUM FRAMED WINDOW, POWDERCOAT FINISH WITH MATCHING FLYSCREENS	1500	910	600	2100	C23	ALUMINIUM FRAMED WINDOW, POWDERCOAT FINISH WITH MATCHING FLYSCREENS	1800	910	300	2100
6	ALUMINIUM FRAMED WINDOW, POWDERCOAT FINISH WITH MATCHING FLYSCREENS	1500	910	600	2100	C24	ALUMINIUM FRAMED WINDOW, POWDERCOAT FINISH WITH MATCHING FLYSCREENS	1800	910	300	2100
7	ALUMINIUM FRAMED WINDOW, POWDERCOAT FINISH WITH MATCHING FLYSCREENS	1500	910	600	2100	C25	ALUMINIUM FRAMED WINDOW, POWDERCOAT FINISH WITH MATCHING FLYSCREENS	1800	910	300	2100
8	ALUMINIUM FRAMED WINDOW, POWDERCOAT FINISH WITH MATCHING FLYSCREENS	1800	910	300	2100	C26	ALUMINIUM FRAMED WINDOW, POWDERCOAT FINISH WITH MATCHING FLYSCREENS	1800	910	300	2100
	ALUMINIUM FRAMED WINDOW, POWDERCOAT FINISH WITH MATCHING FLYSCREENS	1800	910	300	2100	C27	ALUMINIUM FRAMED WINDOW, POWDERCOAT FINISH WITH MATCHING FLYSCREENS	1800	910	300	2100
	ALUMINIUM FRAMED WINDOW, POWDERCOAT FINISH WITH MATCHING FLYSCREENS	1800	910	300	2100	C28	ALUMINIUM FRAMED WINDOW, POWDERCOAT FINISH WITH MATCHING FLYSCREENS	1800	910	300	2100
11	ALUMINIUM FRAMED WINDOW, POWDERCOAT FINISH WITH MATCHING FLYSCREENS	1800	910	300	2100	C29	ALUMINIUM FRAMED WINDOW, POWDERCOAT FINISH WITH MATCHING FLYSCREENS	1800	910	300	2100
	ALUMINIUM FRAMED WINDOW, POWDERCOAT FINISH WITH MATCHING FLYSCREENS	1800	910	300	2100			1	1	1	-1

ISSUED FOR DEVELOPMENT APPLICATION NOT FOR CONSTRUCTION

DRAWING	AMENDMENTS		REX ST GROUP HOME	+L TIM LEE	
REVISION	DESCRIPTION DEVELOPMENT APPLICATION	DATE 23/05/2025	DOUBLE SKULL PTY LTD	residential commercial industrial P: 02 4822 5934 ABN: 71425067537	
			Figured dimensions take precedence. Do not scale drawings.  Builder to check all levels datum and dimensions on the job, conflicting information to be resolved by the project manager prior to commencing work. All materials and workmanship to be in restrict accordance with current Australian standards, BCA, Local regulation and manufacturers current printed instructions. Unless noted otherwise use only best quality materials, fittings and fixtures.  COPYRIGHT TIM LEE ARCHITECTS  Drawings subject to copyright and may not be reproduced in any form without the written permission of the architect.	ROSS PLACE GOULBURN NSW 2580 NOMINATED ARCHITECT: TIM LEE NSW REG: 7304 ACT REG: 1030	STRE

	DRAWING TITLE	DRAWING COMMENCED	DRAWING VERIFIED BY	
A ARCHITECTS	WINDOW SCHEDULE COMMUNAL BUILDING	12/24	TL	
residential commercial industrial	LOT AND DEPOSITED PLAN NO.	DRAWING SCALE	DRAWN BY	
P: 02 4822 5934 ABN: 71425067537	LOT 83 DP 10309		AH	
ROSS PLACE	LOT 65 DI 10309	AT SHEET SIZE	JOB NUMBER	
GOULBURN NSW 2580  NOMINATED ARCHITECT:		A3 SHEET	1024-1723	
TIM LEE	STREET ADDRESS	DRAWING IDENTIFICATION NUMBER	AMENDMENT ISSUE	
NSW REG: 7304 ACT REG: 1030	7 REX STREET GOULBURN	A-22	А	

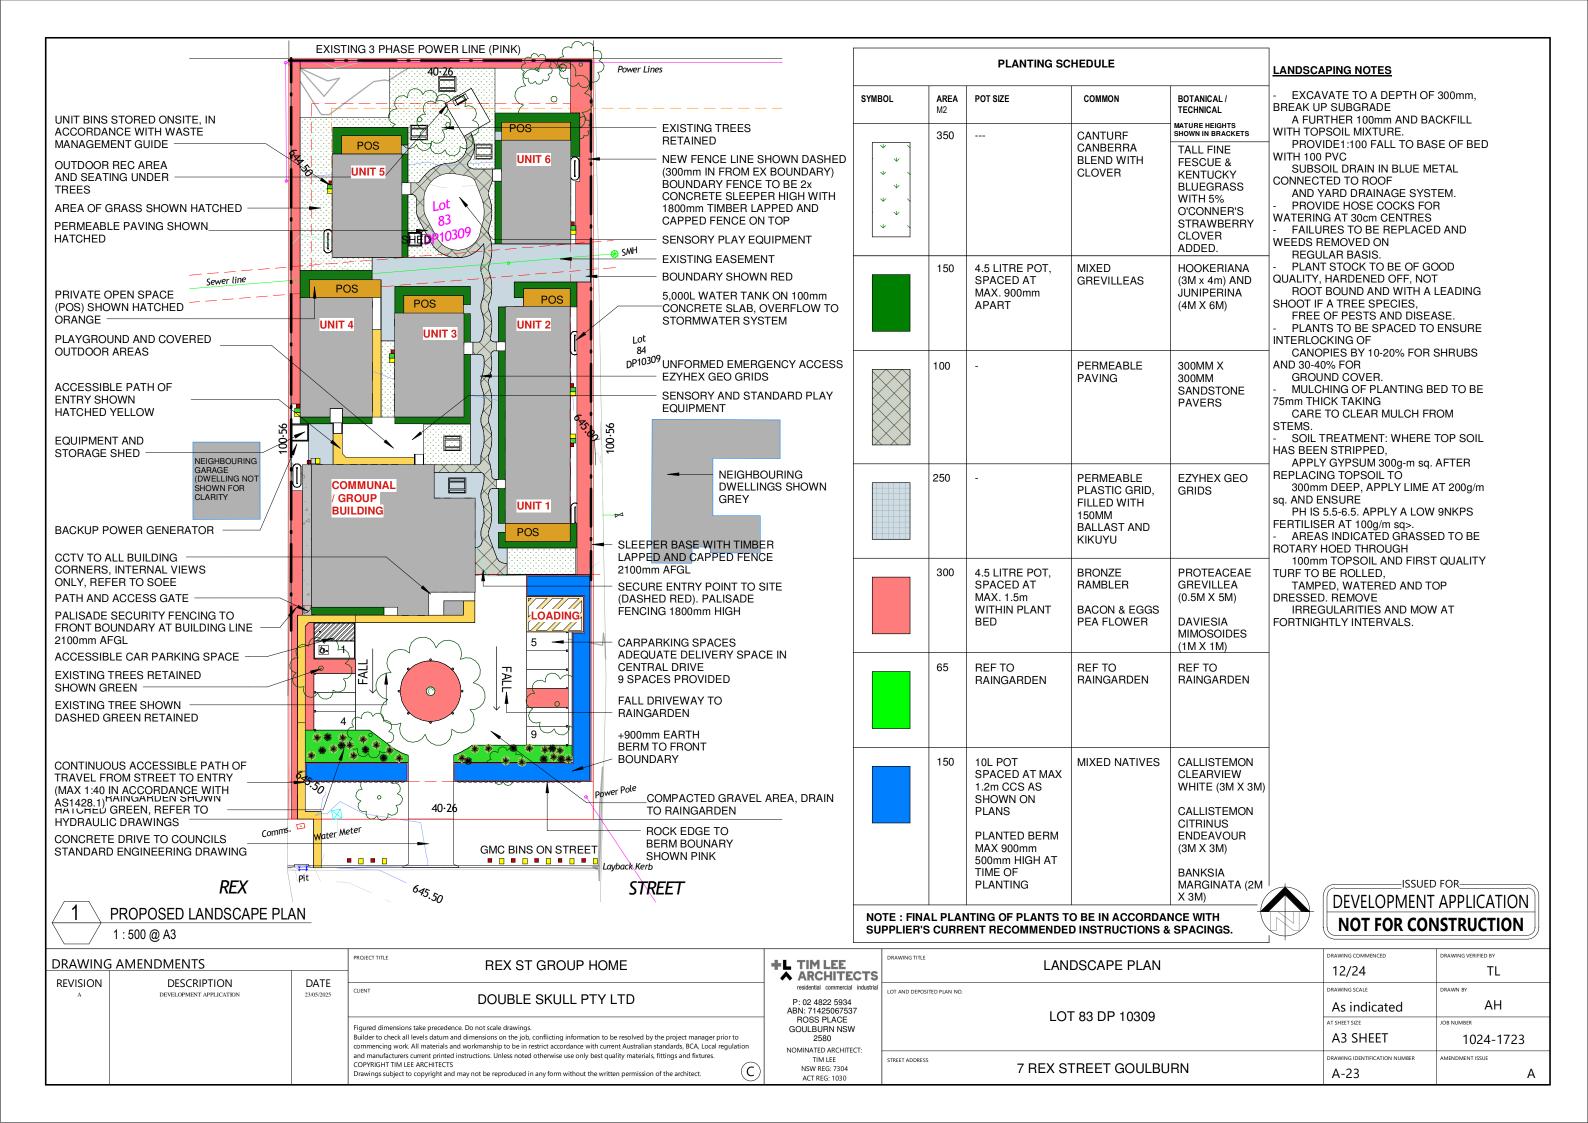





FRONT VIEW FROM REX STREET



VIEW FROM ENTRY DRIVE



WEST APPROACH REX STREET



AXONOMETRIC VIEW



VIEW FROM GARDEN





VIEW FROM GARDEN

residence to	18000 1900dti	M. Anna Carlotta	HARLIN THE FILLY OF THE PARTY	Market State VIII	and the same of th
DRAWING	S AMENDMENTS		PROJECT TITLE	REX ST GROUP HOME	
REVISION	DESCRIPTION  DEVELOPMENT APPLICATION	DATE 23/05/2025	CLIENT	DOUBLE SKULL PTY LTD	
			1 -	precedence. Do not scale drawings. s datum and dimensions on the job, conflicting information to be resolved by the project	manager prior to

l	Figured dimensions take precedence. Do not scale drawings.	
l	Builder to check all levels datum and dimensions on the job, conflicting information to be resolved by the project manager prior	rto
l	commencing work. All materials and workmanship to be in restrict accordance with current Australian standards, BCA, Local regu	ulation
l	and manufacturers current printed instructions. Unless noted otherwise use only best quality materials, fittings and fixtures.	
l	COPYRIGHT TIM LEE ARCHITECTS	6
ı	Drawings subject to convigant and may not be reproduced in any form without the written permission of the architect	( (

	AL TIMLEE	DRAWING TITLE CONTOCEDED DENIDEDO	DRAWING COMMENCED	DRAWING VERIFIED BY
<b>↑L</b> TIM LEE	CONCEPT RENDERS	12/24	TL	
	residential commercial industrial	LOT AND DEPOSITED PLAN NO.	DRAWING SCALE	DRAWN BY
P: 02 4822 5934 ABN: 71425067537 ROSS PLACE GOULBURN NSW 2580 NOMINATED ARCHITECT: TIM LEE NSW REG: 7304 ACT REG: 1030	ABN: 71425067537	LOT 83 DP 10309		АН
	LOT 65 DF 10309	AT SHEET SIZE	JOB NUMBER	
	2580		A3 SHEET	1024-1723
	TIM LEE NSW REG: 7304	7 REX STREET GOULBURN	DRAWING IDENTIFICATION NUMBER	AMENDMENT ISSUE
			A-26	А

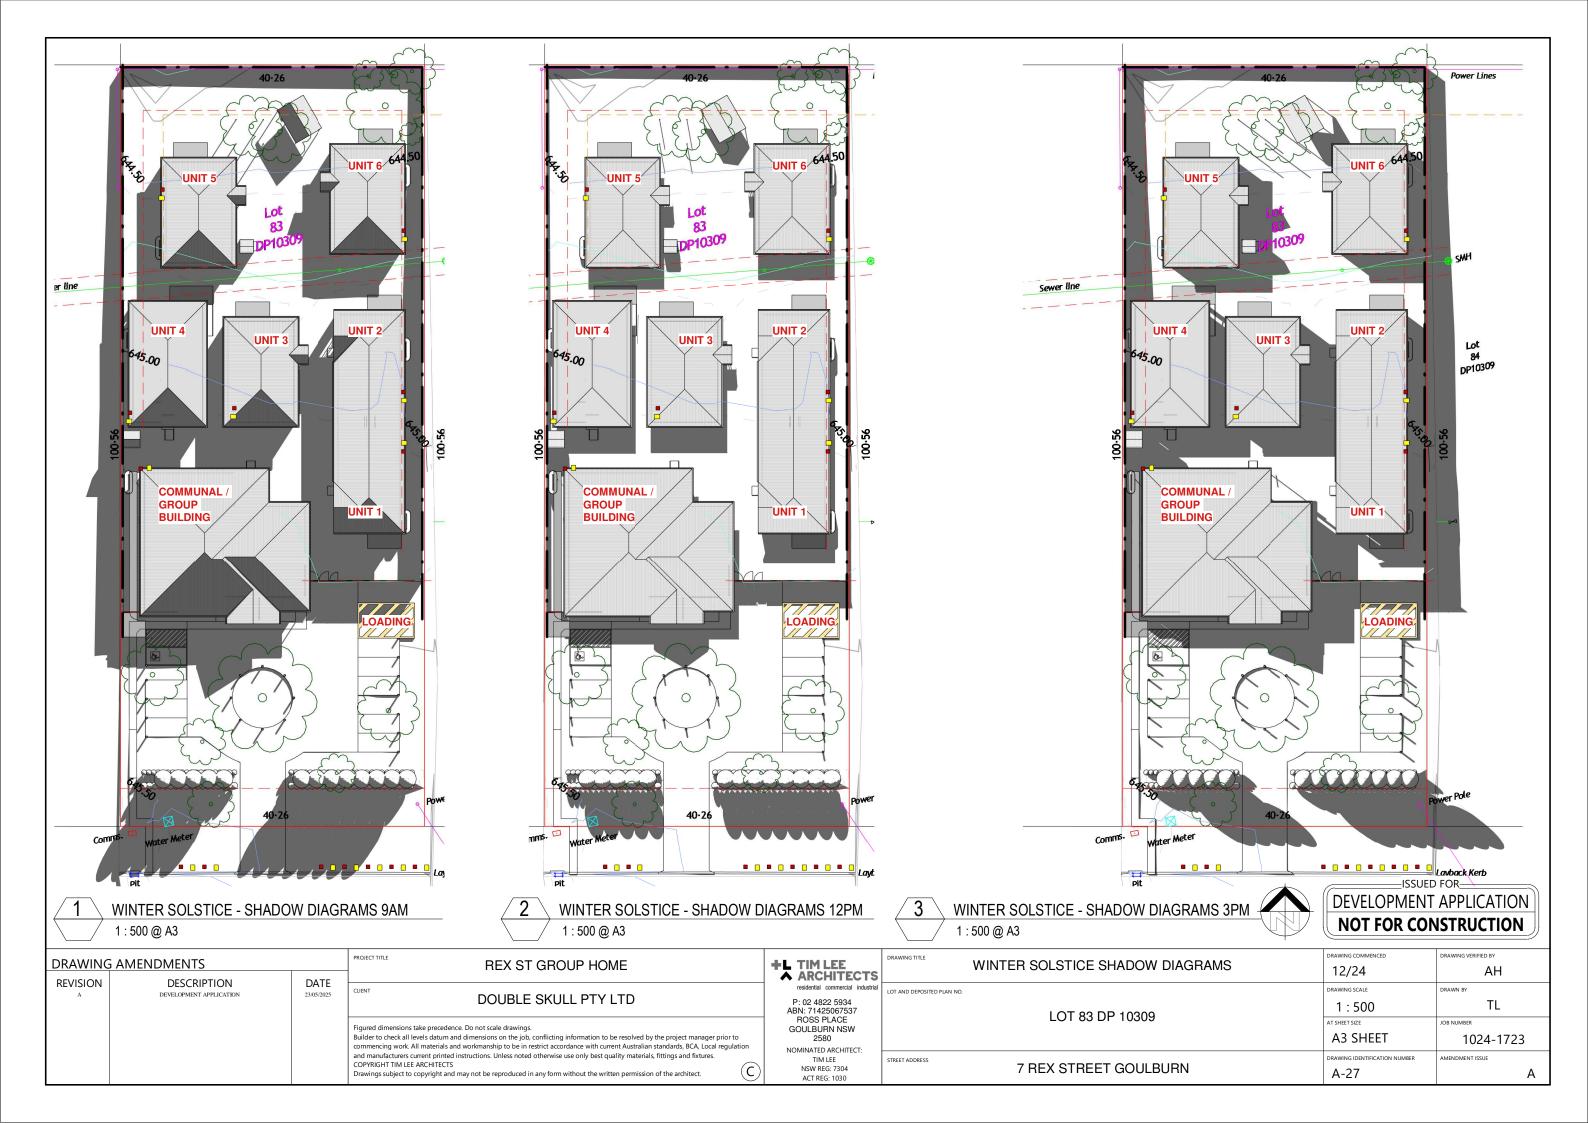

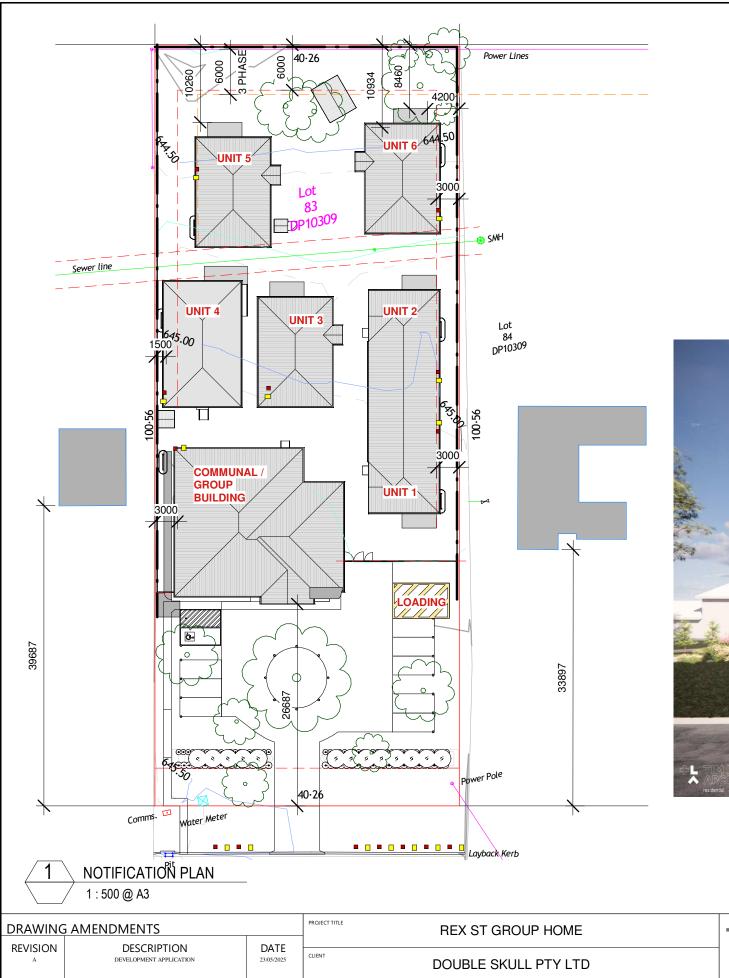

Figured dimensions take precedence. Do not scale drawings.

Builder to check all levels datum and dimensions on the job, conflicting information to be resolved by the project manager prior to commencing work. All materials and workmanship to be in restrict accordance with current Australian standards, BCA, Local regulation and manufacturers current printed instructions. Unless noted otherwise use only best quality materials, fittings and fixtures.

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STREET ELEVATION 1:200 @ A3



VIEW FROM STREET

**+L** TIM LEE

▲ ARCHITECTS

P: 02 4822 5934 ABN: 71425067537 ROSS PLACE GOULBURN NSW 2580 NOMINATED ARCHITECT: TIM LEE NSW REG: 7304

DRAWING TITLE		DRAWING COMMENCED	DRAWING VERIFIED BY
	NOTIFICATION PLAN	12/24	TL
LOT AND DEPOSITED PLAN NO.		DRAWING SCALE DRAWN BY	
	LOT 83 DP 10309		АН
	LOT 03 DI 10309	AT SHEET SIZE	JOB NUMBER
			1024-1723
STREET ADDRESS		DRAWING IDENTIFICATION NUMBER AMENDMENT ISSUE	
	7 REX STREET GOULBURN		А

DEVELOPMENT APPLICATION **NOT FOR CONSTRUCTION** 

\_ISSUED FOR\_